
#### DRAWING LIST L-0.0 Cover Sheet Level 1 Materials & Grading Plan L-1.1 L-1.2 Level 1 Planting Plan L-1.3 Level 1 Soil Depths L-1.4 Level 3 Materials Plan L-1.5 Level 3 Planting Plan L-1.6 Level 3 Soil Depths L-1.7 Rooftop Materials Plan L1.8 **Rooftop Planting Plan** L-1.9 Rooftop Soil Dephts L-2.1 Landscape Sections L-3.1 Landscape Details L-3.2 Landscape Details L-3.3 Landscape Details

### Legend

42" Guardrail Privacy Screen \_\_\_\_ Overhana Extent of Slab ----6' High Fence at PL <del>×××</del> Fence at Dog Area

#### Materials Legend $\langle S1 \rangle$ Shrub and Perennial Planting Privacy hedge $\langle s_3 \rangle$ **Urban Agriculture** $\langle S4 \rangle$ Sodded Lawn $\langle S5 \rangle$ Poured in Place Rubber Resilient Surfacing $\langle S6 \rangle$ 18x18" Hydrapressed Concrete slabs $\langle S7 \rangle$ 18x18" Hydrapressed Concrete slabs Concrete Pavers 2 tone (Slip resistant) **CIP Concrete** $\langle S9 \rangle$ **S10** Dainage Gravel **(S11)** Decorative gravel

36"x12" Hydrapressed Concrete slabs

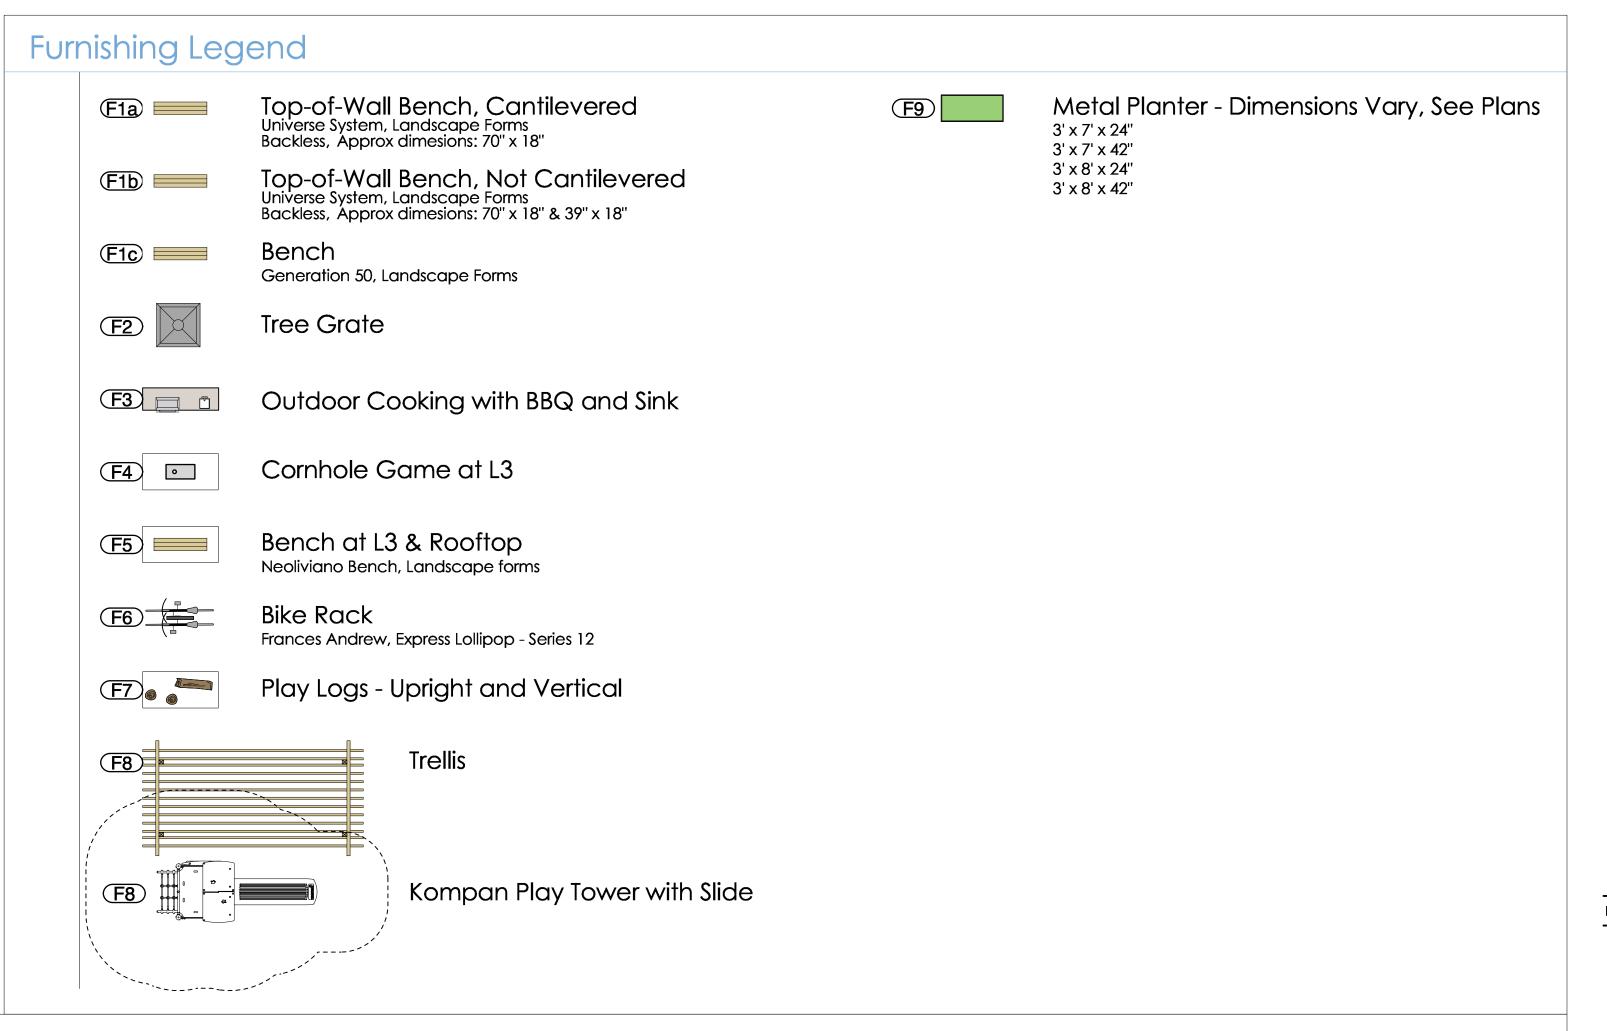

#### 2023-08-31 For DP Re-Submission 2023-03-03 For DP no.: |date: Revision: **DURANTE KREUK LTD.** 102 - 1637 West 5th Avenue Vancouver B.C. V6J 1N5 P:604.684.4611 F:604.684.0577 www .dkl.bc.ca

### Grading & Drainage Legend

XSVY 16.72m Exiting Survey Grade Finished Grade **X**16.72m Top of Wall 16.72m Bottom of Wall **X**BW 16.72m Direction, % Slope Down 2.0% Direction, # of Risers Down

### Lighting & Irrigation Legend

Shown as reference only. Refer to Electrical and Mecanical drawings for full information. Down Lighting in Trellis

Recessed Wall Lighting Sheilded, Down lit, Energy Efficient

**Artificial Turf** 

Structural Soil

Exterior Lighting on Building See ARCH

SIZE/SPACING

#1 pot / 24" O.C.

#2 pot / 24" O.C.

Hose Bib

**COMMON NAME** 

Gumbo Pink Azalea

bearberry cotoneaster

Kelsey's Dwarf Red-Osier Dogwood #2 pot / 24" O.C.

S12

S13

#### General Notes

- Refer to architectural drawings for all walls and stair layout and elevations, unless otherwise noted.
- Refer to electrical drawings for all final landscape lighting layout and specifications. Refer to architectural and mechanical drawings for all drain locations and rim elevations.

- All work shall meet or exceed the requirements as outlined in the Current Edition of the Canadian Landscape Standard.
- Plant selection subject to availability at the time of planting.
- Contractor shall source specified plant material and only after area of search has been exhausted will
- substitutions be considered. All trees to be staked in accordance with CLA Standards.
- All plants to be sourced from nurseries certified free of P. ramorum.
- Plant sizes and related container classes are specified according to the B.C. Landscape Standards current edition. For container classes #3 and smaller, plant sizes shall be as shown in the plant list and the standard; for all other plants, both plant size and container calls shall be as shown in the plant list. Specifically, when the plant list calls for #5 class containers, these shall be as defined in the CLA (ANSI) Standard.
- All trees to have minimum 10 cubic meters of growing medium unless otherwise specified.
- All On-site 'Soft Landscape Areas' to be irrigated to IIABC Standards with a high efficiency irrigation system. Design of irrigation system to be submitted to consultant and reviewed prior to installation. The irrigation system design and installation shall be in accordance with the Irrigation Industry of BC Standards and

#### Soil Preparation and Placement Notes

- All growing medium placed on project to meet or exceed CLA and B.C Landscape Standards
- Submit sieve analysis by an approved independent soil testing laboratory for each type of growing medium being used on the project PRIOR to placement for review and approval. Clearly identify source and type for each. Resubmit as required until growing medium is approved. Provide one composite sample of each type of proposed growing medium for each different application within the project. Minimum 1 litre physical sample.
- Submittals shall be made at least seven (7) days prior placement.
- Contractor shall not move or work growing medium or additives when they are excessively wet, extremely dry, or frozen or in any manner which will adversely affect growing medium structure. Growing medium whose structure has been destroyed by handling under these conditions will be
- rejected. Growing medium shall not be handled in wet or frozen conditions. Slab drainage shall be 19mm (3/4") diameter drain gravel free from any silt and clay as shown in
- Place growing medium, except structural to required finish grades and minimum depths as detailed, unless shown otherwise.

#### **Product and Material Notes**

- All materials to be as specified or pre-approved equivalent. All material and products to be installed per manufacturer's specifications.

### Design Rationale

Guidelines.

Located in the Sapperton neighbourhood of New Westminster the site is situated on a diverse and developing, 'Great Street' within the municipality. Fronting East Columbia Street and bounded by Strand Avenue and Alberta Street the site is within walking distance of a sky train station, hospital, park spaces, elementary school, retail, and housing.

Despite the challenging grading all entrances are accessible for users of all ages and abilities. A combination of steps and 2.5m flush entry connections into the commercial/retail area allow users to seamlessly move between the spaces. Lighting is also provided for visibility at all entrances. Rhythmically stepped planting and seating along East Columbia provides an opportunity for people alone or in groups to enjoy the public realm.

Bike racks are located next to East Columbia Street for the convenience of those traveling along the adjacent bike lane. Additional bike racks are located adjacent to the residential entry point on Strand Avenue and at the office entry point on Alberta Street, thus providing convenient short term bike parking options for all building uses.

The outdoor common space on level 3 provides passive play equipment with seating for residents of all ages aswell as a separated nook for cooking, eating, and relaxing. Private patios adjoining the amenity space are screened by a planter and hedge. Generous outdoor patios have also been provided for many of the homes on Level 3. The rooftop offers a larger play space and urban agriculture spaces which relate towards the play space as a learning tool for children, or for anyone to use at their leisure.

Street trees will be provided in the public realm. Planting throughout the site is a mix of native and adaptive plants to BC. Evergreen shrubs form the backbone of the plant pallet with some perennials and deciduous plants providing seasonal interest and a variety of habitat.

Project:

E Columbia St New Westminister, BC

Draw by: JC Check by: Date: Aug 31, 2023 Scale: Drawing Title:

#### Landscape Cover Page

Project No.: 22035

Sheet No.:

L-0.0


## Plant List


Shrubs

SYMBOLS	NUMBER	BOTANICAL NAME	COMMON NAME	SIZE/SPACING
	2	Cornus kousa var. chinensis	Chinese dogwood	7cm cal / B+B
$\overline{}$	12	Street Trees - Species to be sel	ected by the City	7cm cal / B+B


## **BOTANICAL NAME** NUMBER Azalea 'Gumbo Pink' Cornus sericea 'Kelseyi' Cotoneaster dammeri Hamamalia v intermedia

Cu				<i>"</i> = pot: =: 0:0:
Hi	3	Hamamelis x intermedia	witchhazel	2m ht B&B, Multi-Stem
ls	15	Iberis sempervirens	evergreen candytuft	#1 pot / 18" O.C.
La	25	Lavandula angustifolia	English lavander	#1 pot / 28" O.C.
Lp	15	Lonicera Pileata	privet honeysuckle	#2 pot / 42" O.C.
Rkj	39	Rhododendron 'Ken Janeck'	Ken Janeck rhododendron	#2 pot / 36" O.C.
Ri	6	Rhododendron impeditum	dwarf purple rhododendron	#2 pot / 30" O.C.
Sh	26	Sarcococca hookeriana var. humilis	Himalayan Sweet Box	#1 pot / 18" O.C.
	45	Taxus x media 'Hicksii'	yex hedge	4'h B&B
Vd	3	Viburnum davidii	David viburnum	#2 pot / 60" O.C.
Perennials				
SYMBOLS	NUMBER	BOTANICAL NAME	COMMON NAME	SIZE/SPACING
d	37	Dicentra formosa	Pacific Bleeding Heart	#1 pot / 12" O.C.
f	75	Frangara x ananassa	garden strawberry	#1 pot / 6" O.C.
ho	10	Helleborus orientalis	lenten Rose	#1 pot / 18" O.C.
L	157	Liriope muscari	blue Lily turf	#1 pot / 12' O.C.
nt	4	Nassella tenuissima	Mexican feather grass	#1 pot / 24" O.C.
S	6	Sedum 'Autumn Joy'	Autumn Joy stonecap	#1 pot / 18" O.C.

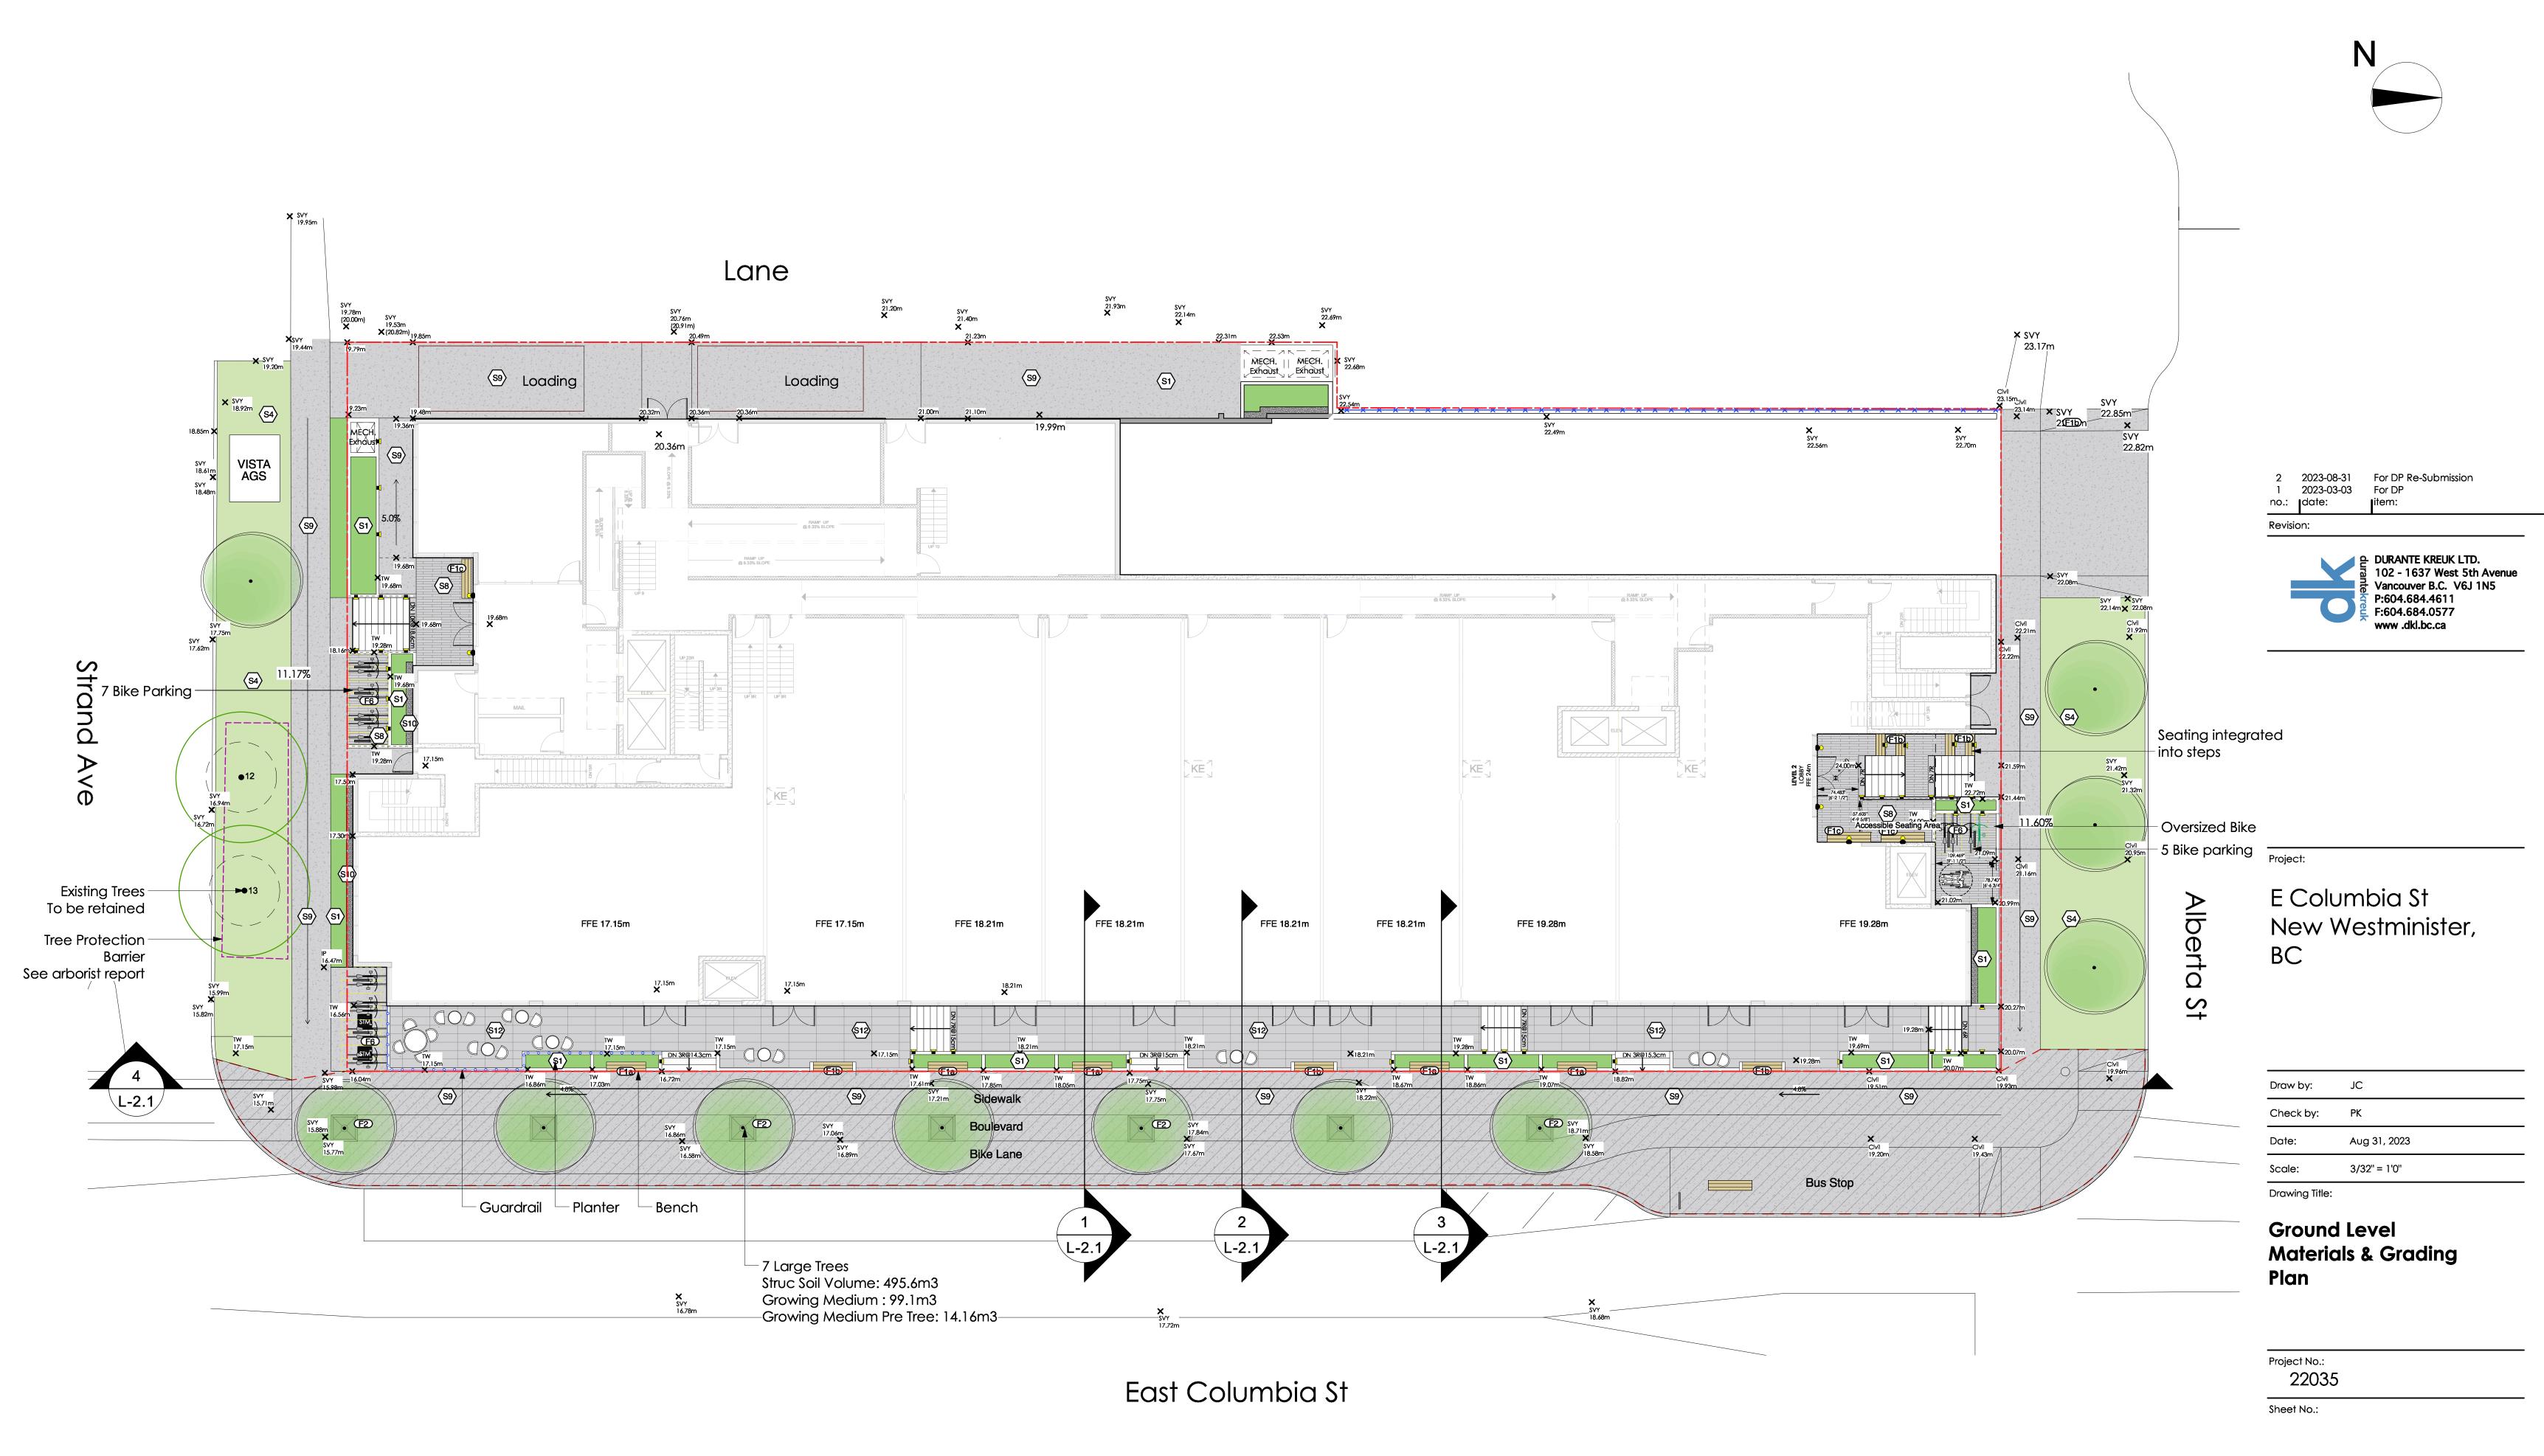

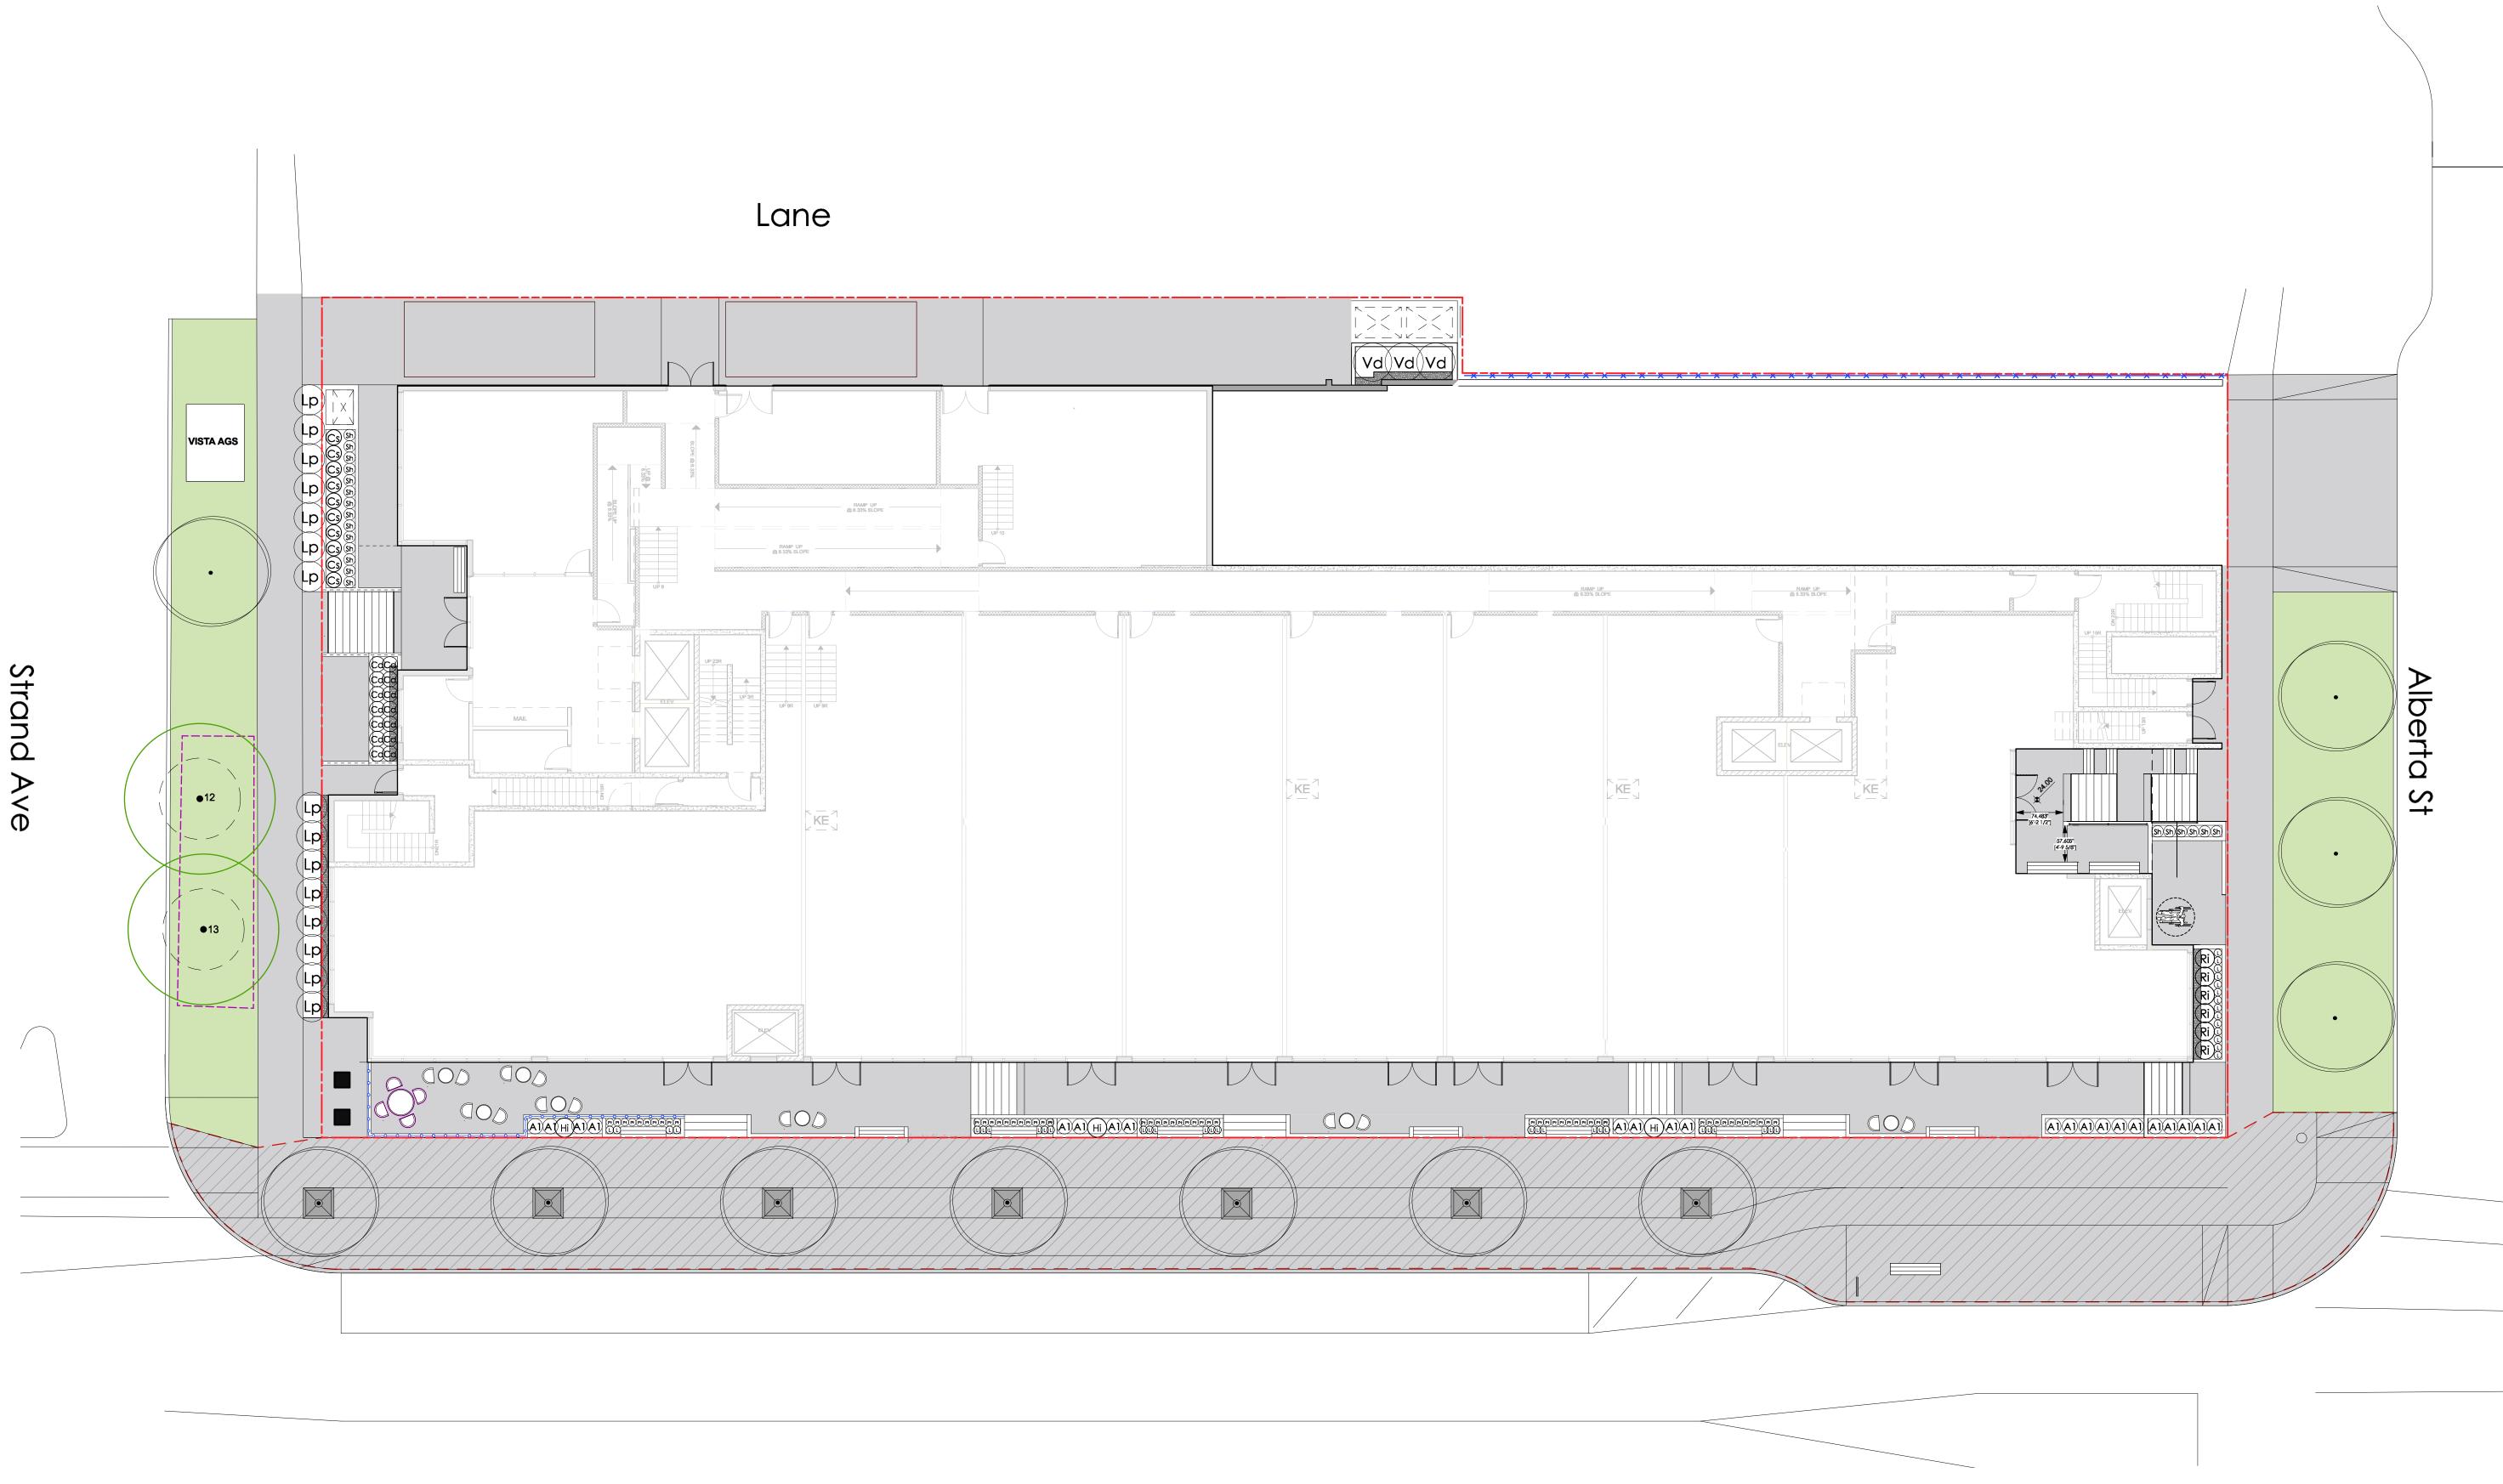

East Columbia St

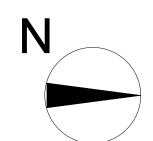

2 2023-08-31 For DP Re-Submission 1 2023-03-03 For DP





E Columbia St New Westminister, BC

Draw by: JC Check by: PK Aug 31, 2023 Date: 3/32" = 1'0" Drawing Title:

**Ground Level Planting Plan Plan** 

Project No.: 22035

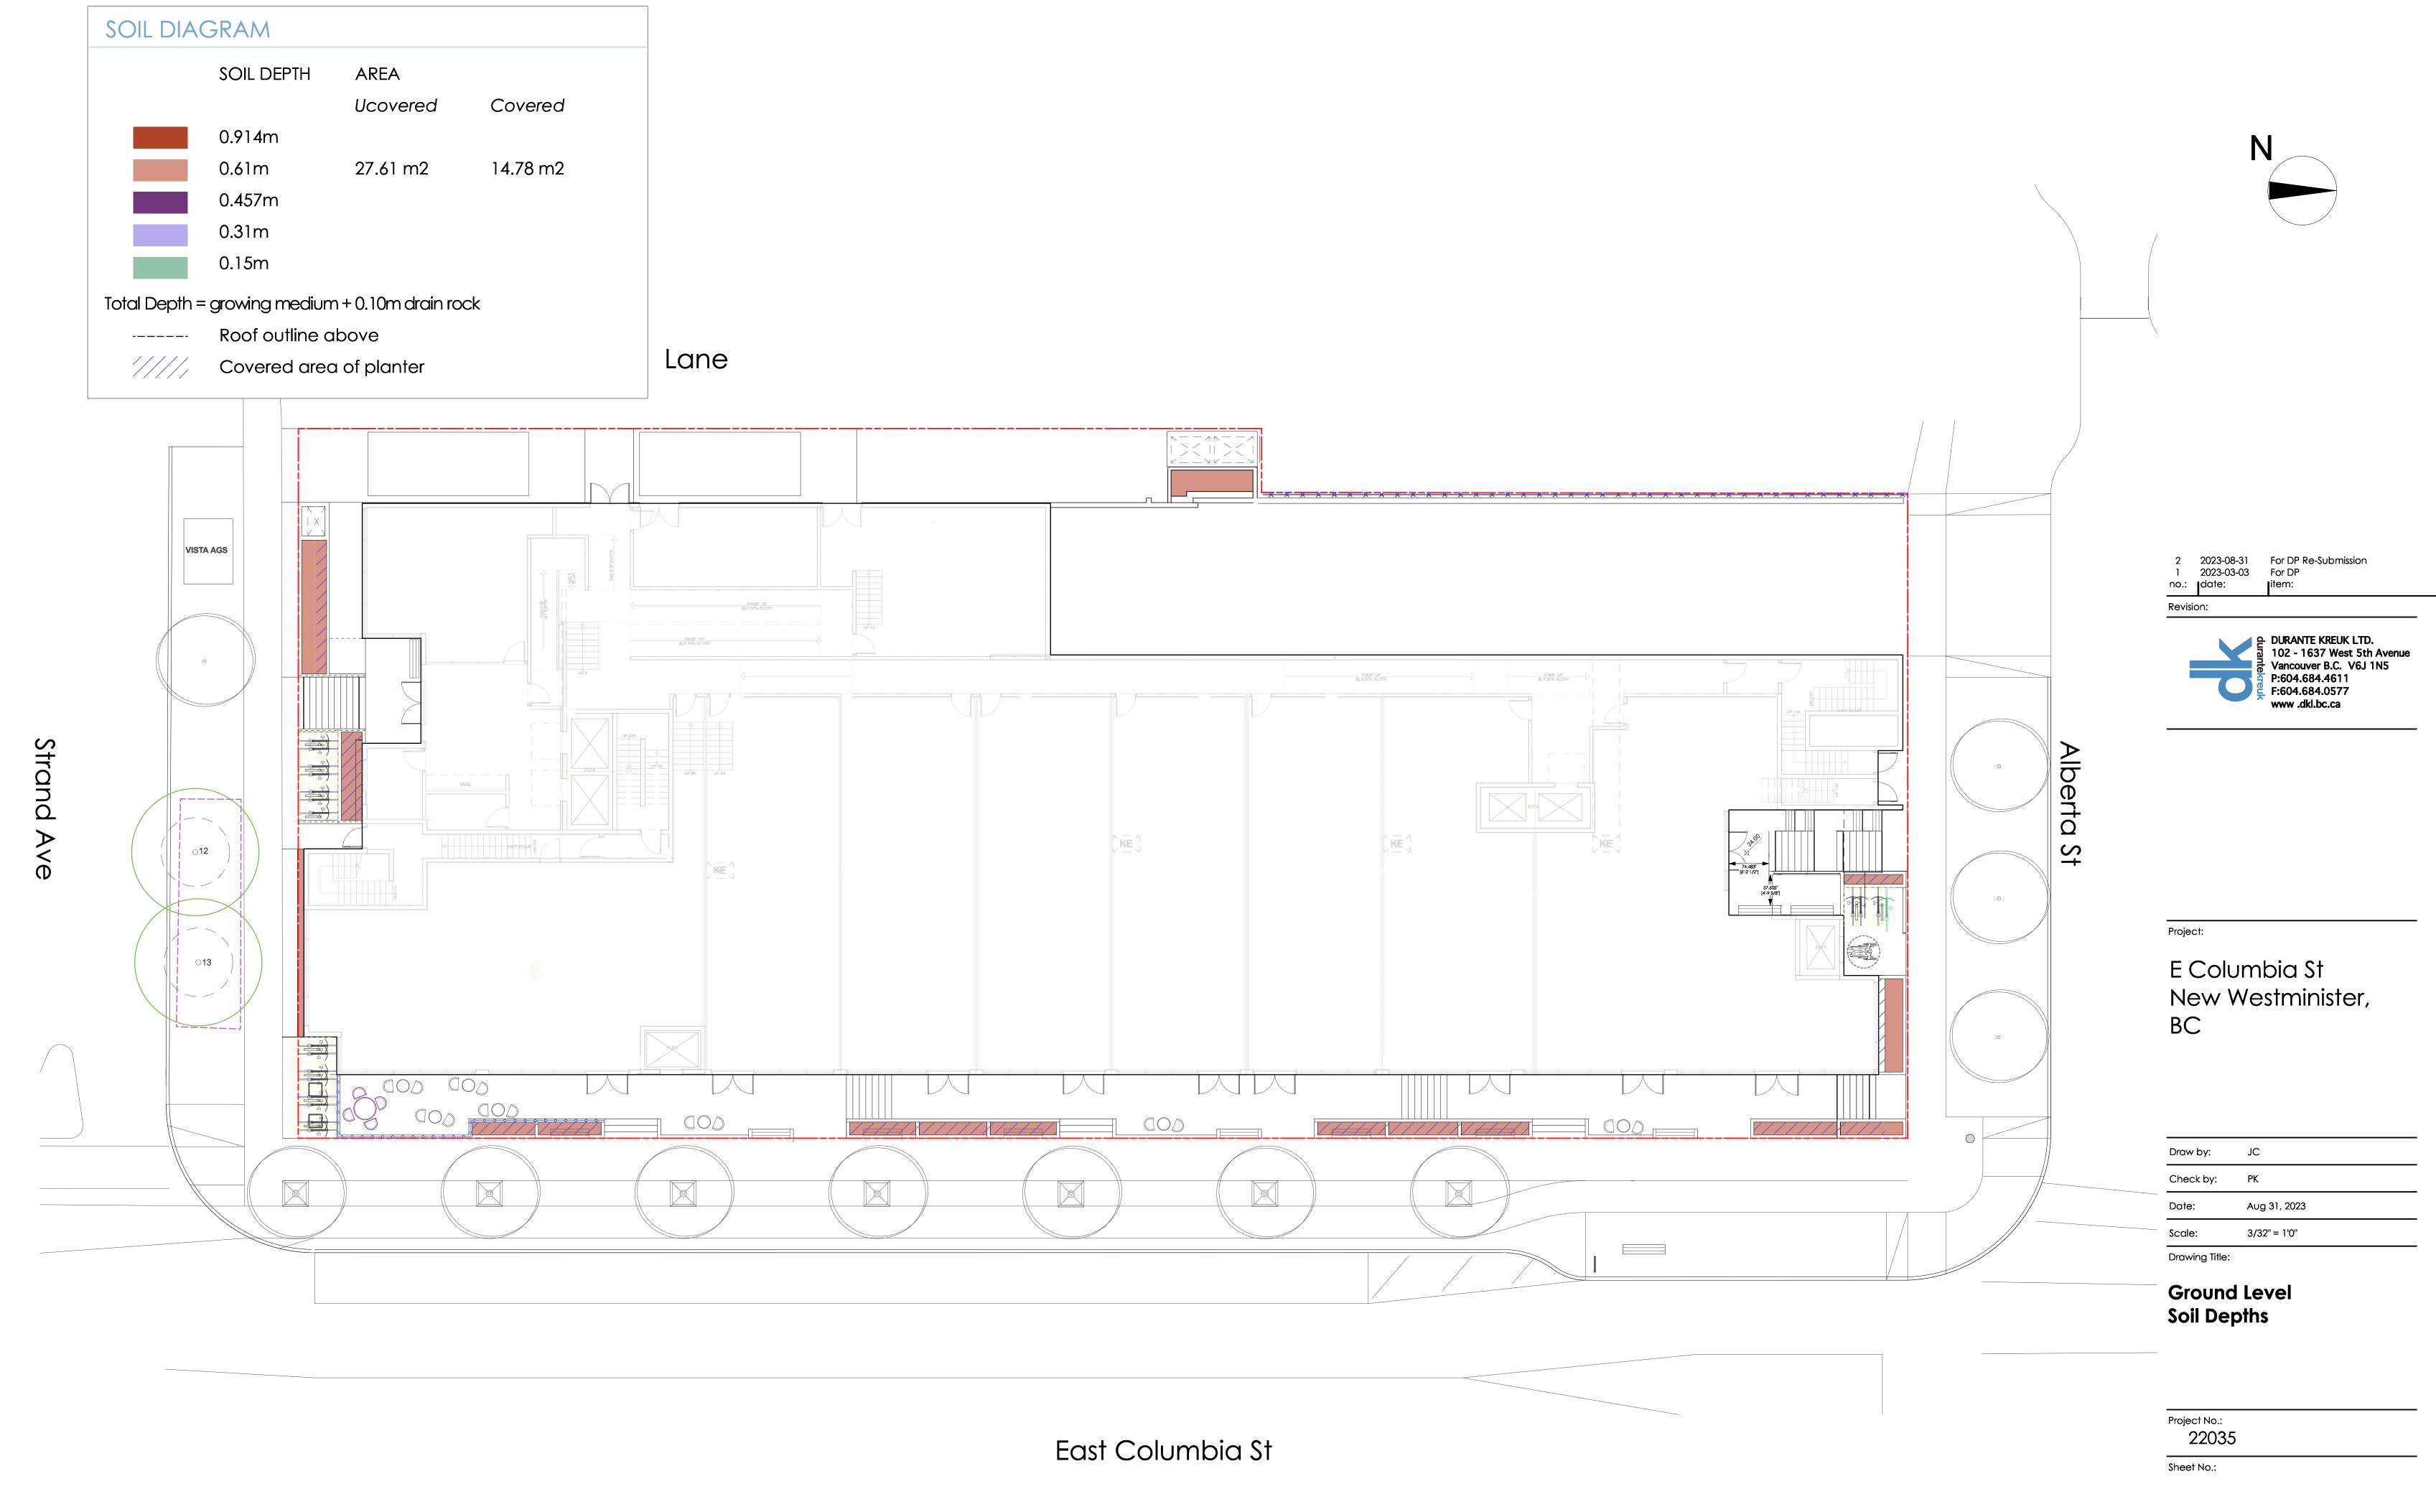


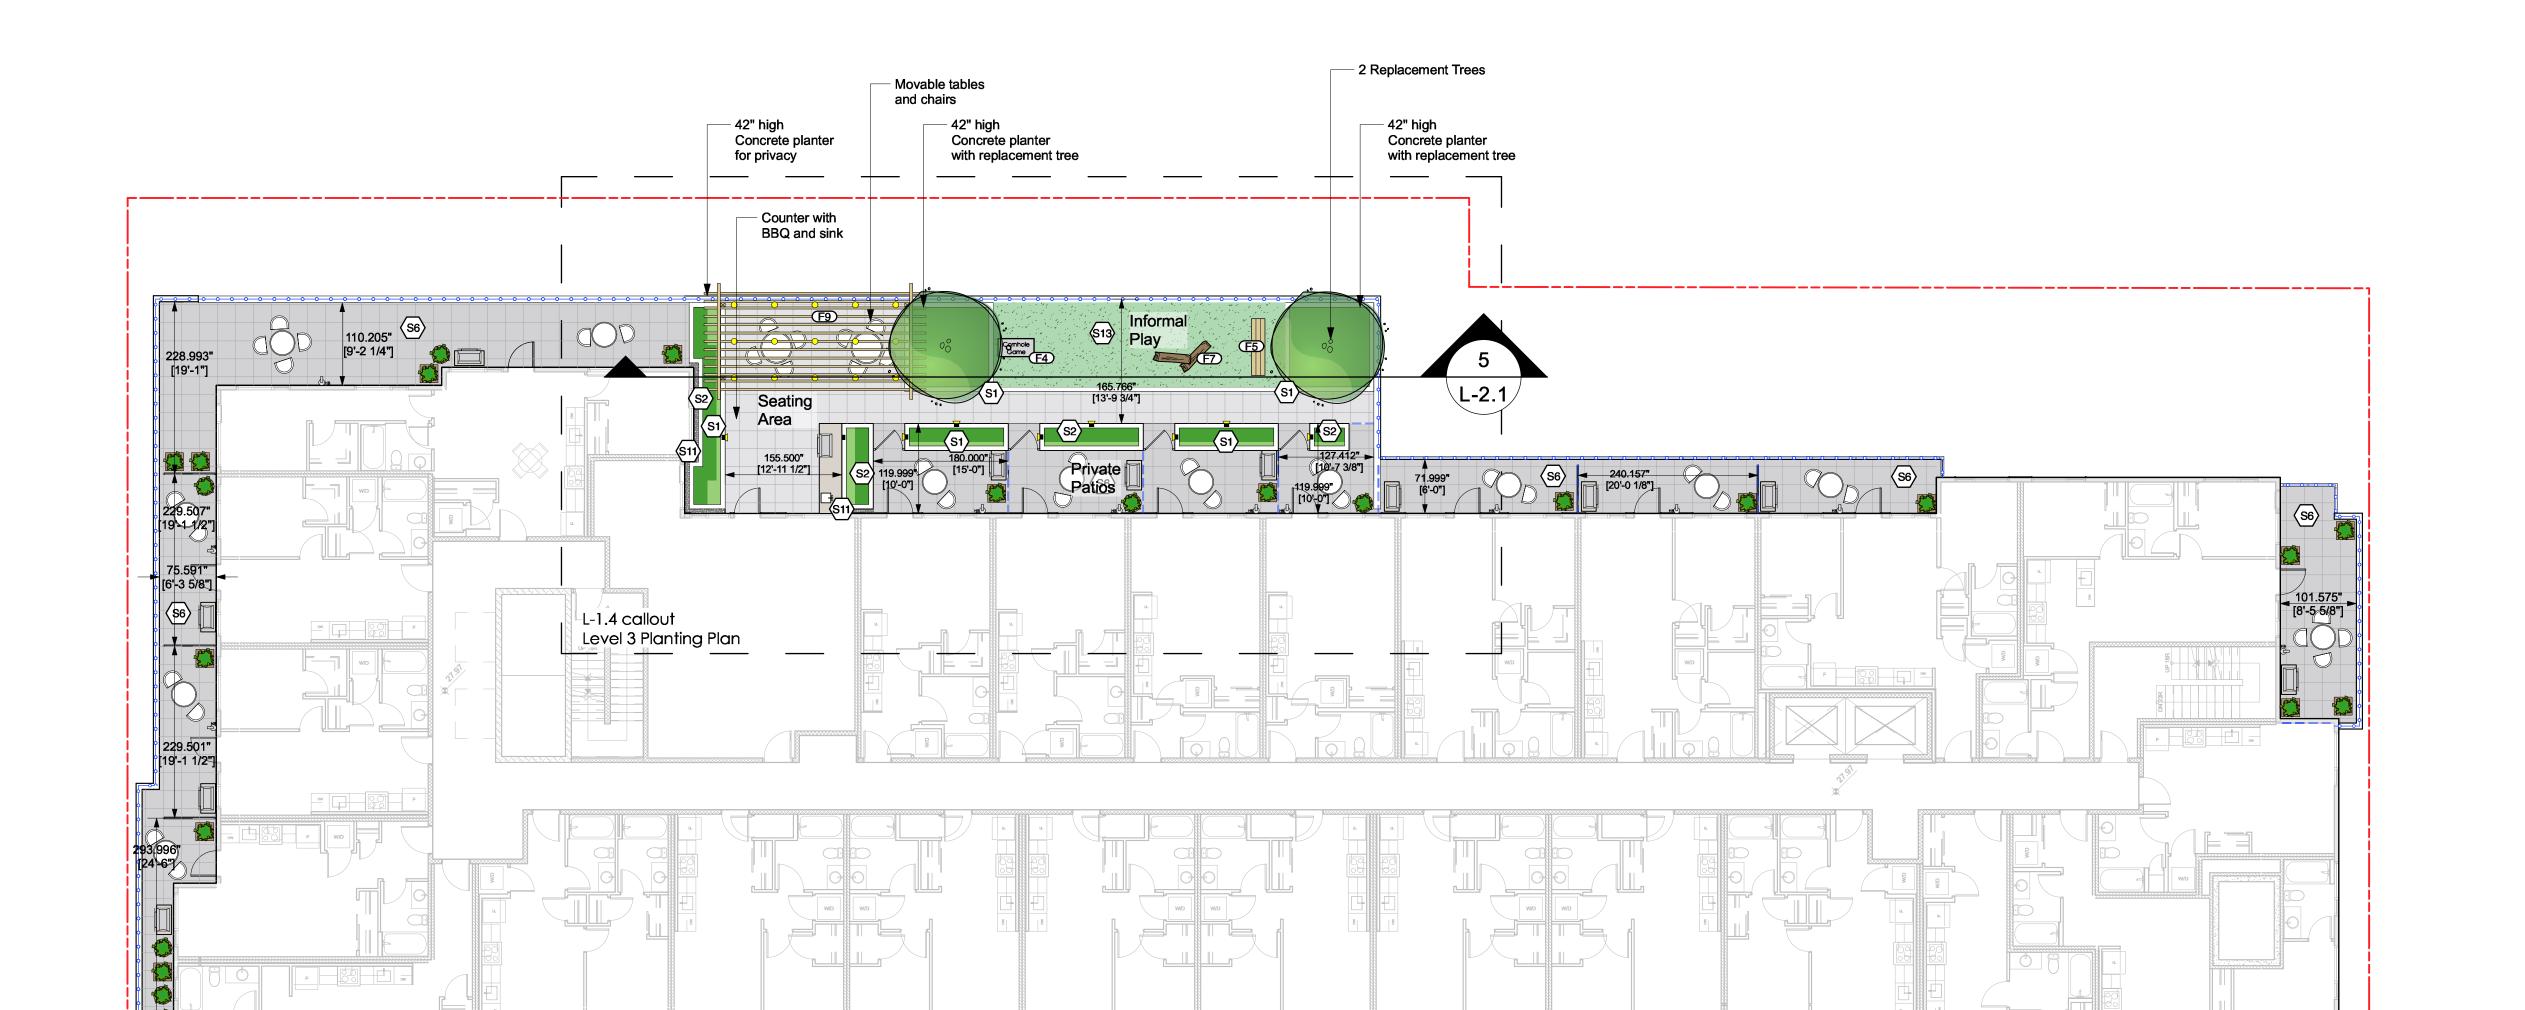

Privacy screen

42" high metal planters

1 72.791" 72.000" [6'-0"]

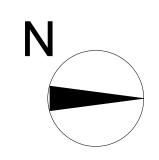

2 2023-08-31 For DP Re-Submission 1 2023-03-03 For DP



Project:

### E Columbia St New Westminister, BC

Draw by:	JC
Check by:	PK
Date:	Aug 31, 2023
Scale:	3/32" = 1'0"

Drawing Title:


\*Patio furniture shown for scale


#### Level 3 **Materials Plan**

Project No.: 22035

Sheet No.:

L-1.4

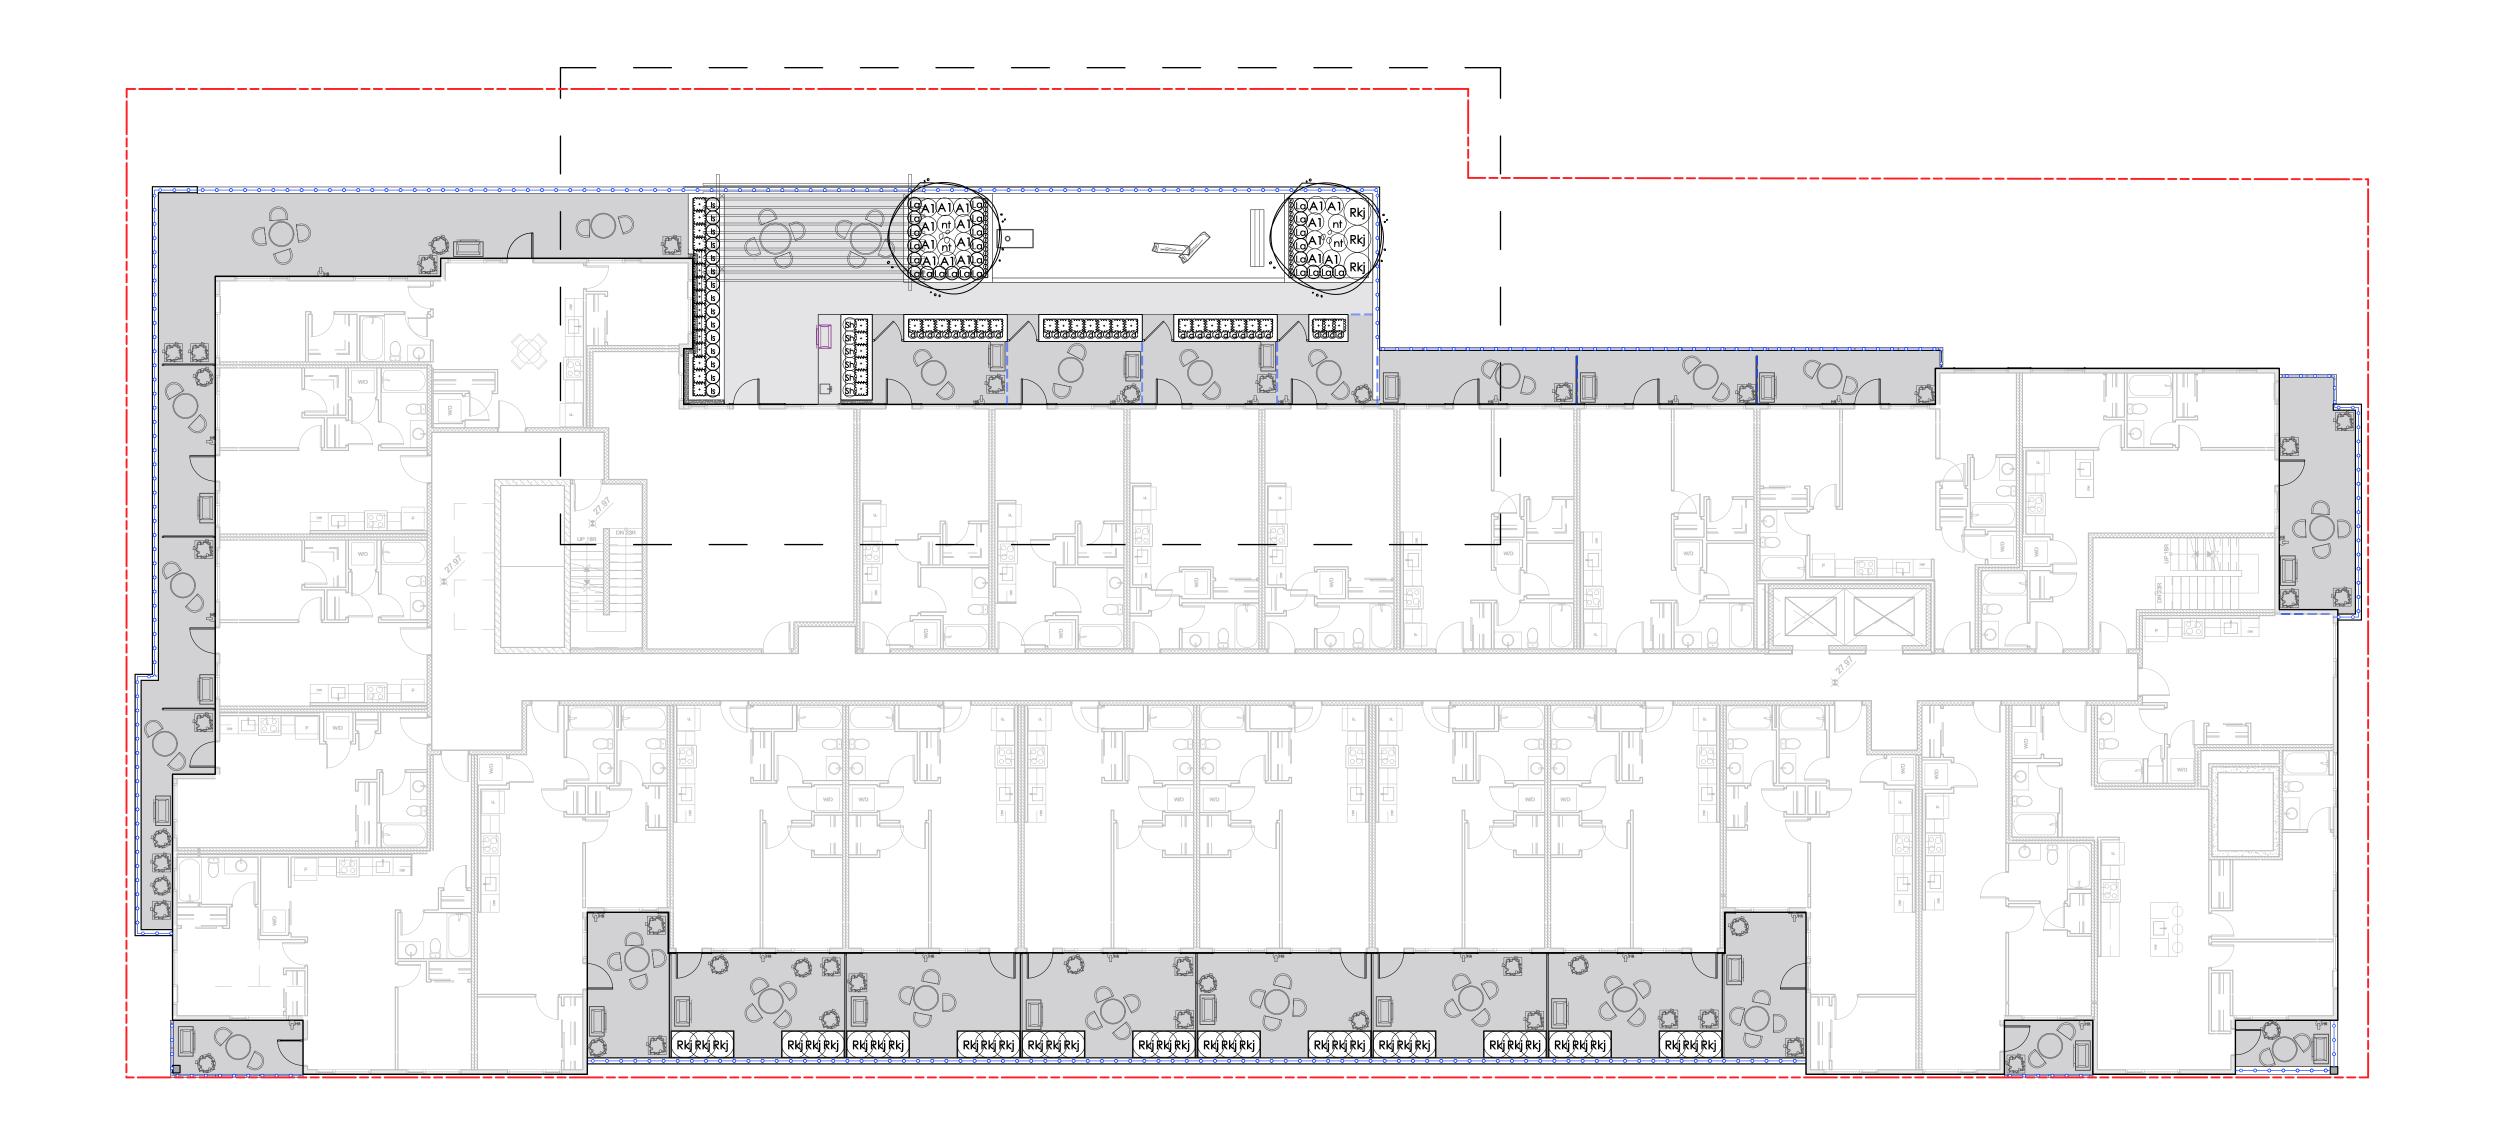

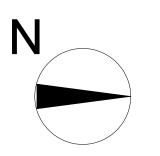

1 2023-03-03 For DP

2 2023-08-31 For DP Re-Submission



Project:

### E Columbia St New Westminister, BC

Draw by:	JC
Check by:	PK
Date:	Aug 31, 2023
Scale:	3/32" = 1'0"


Drawing Title:


# Level 3 Planting Plan


Project No.: 22035

Sheet No.:

L-1.5

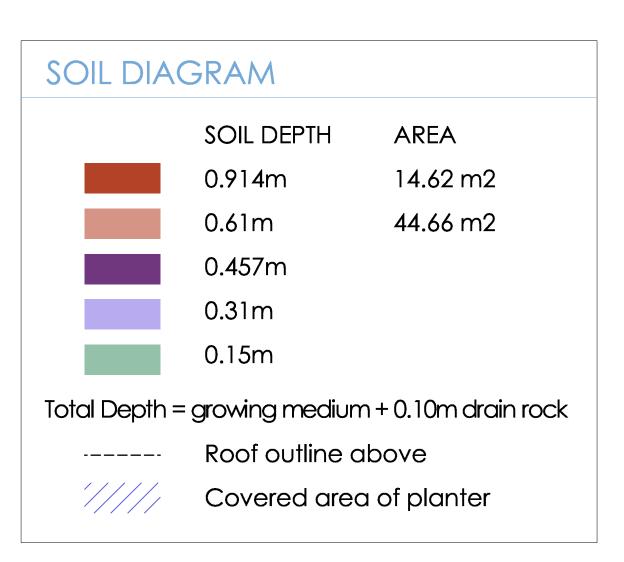

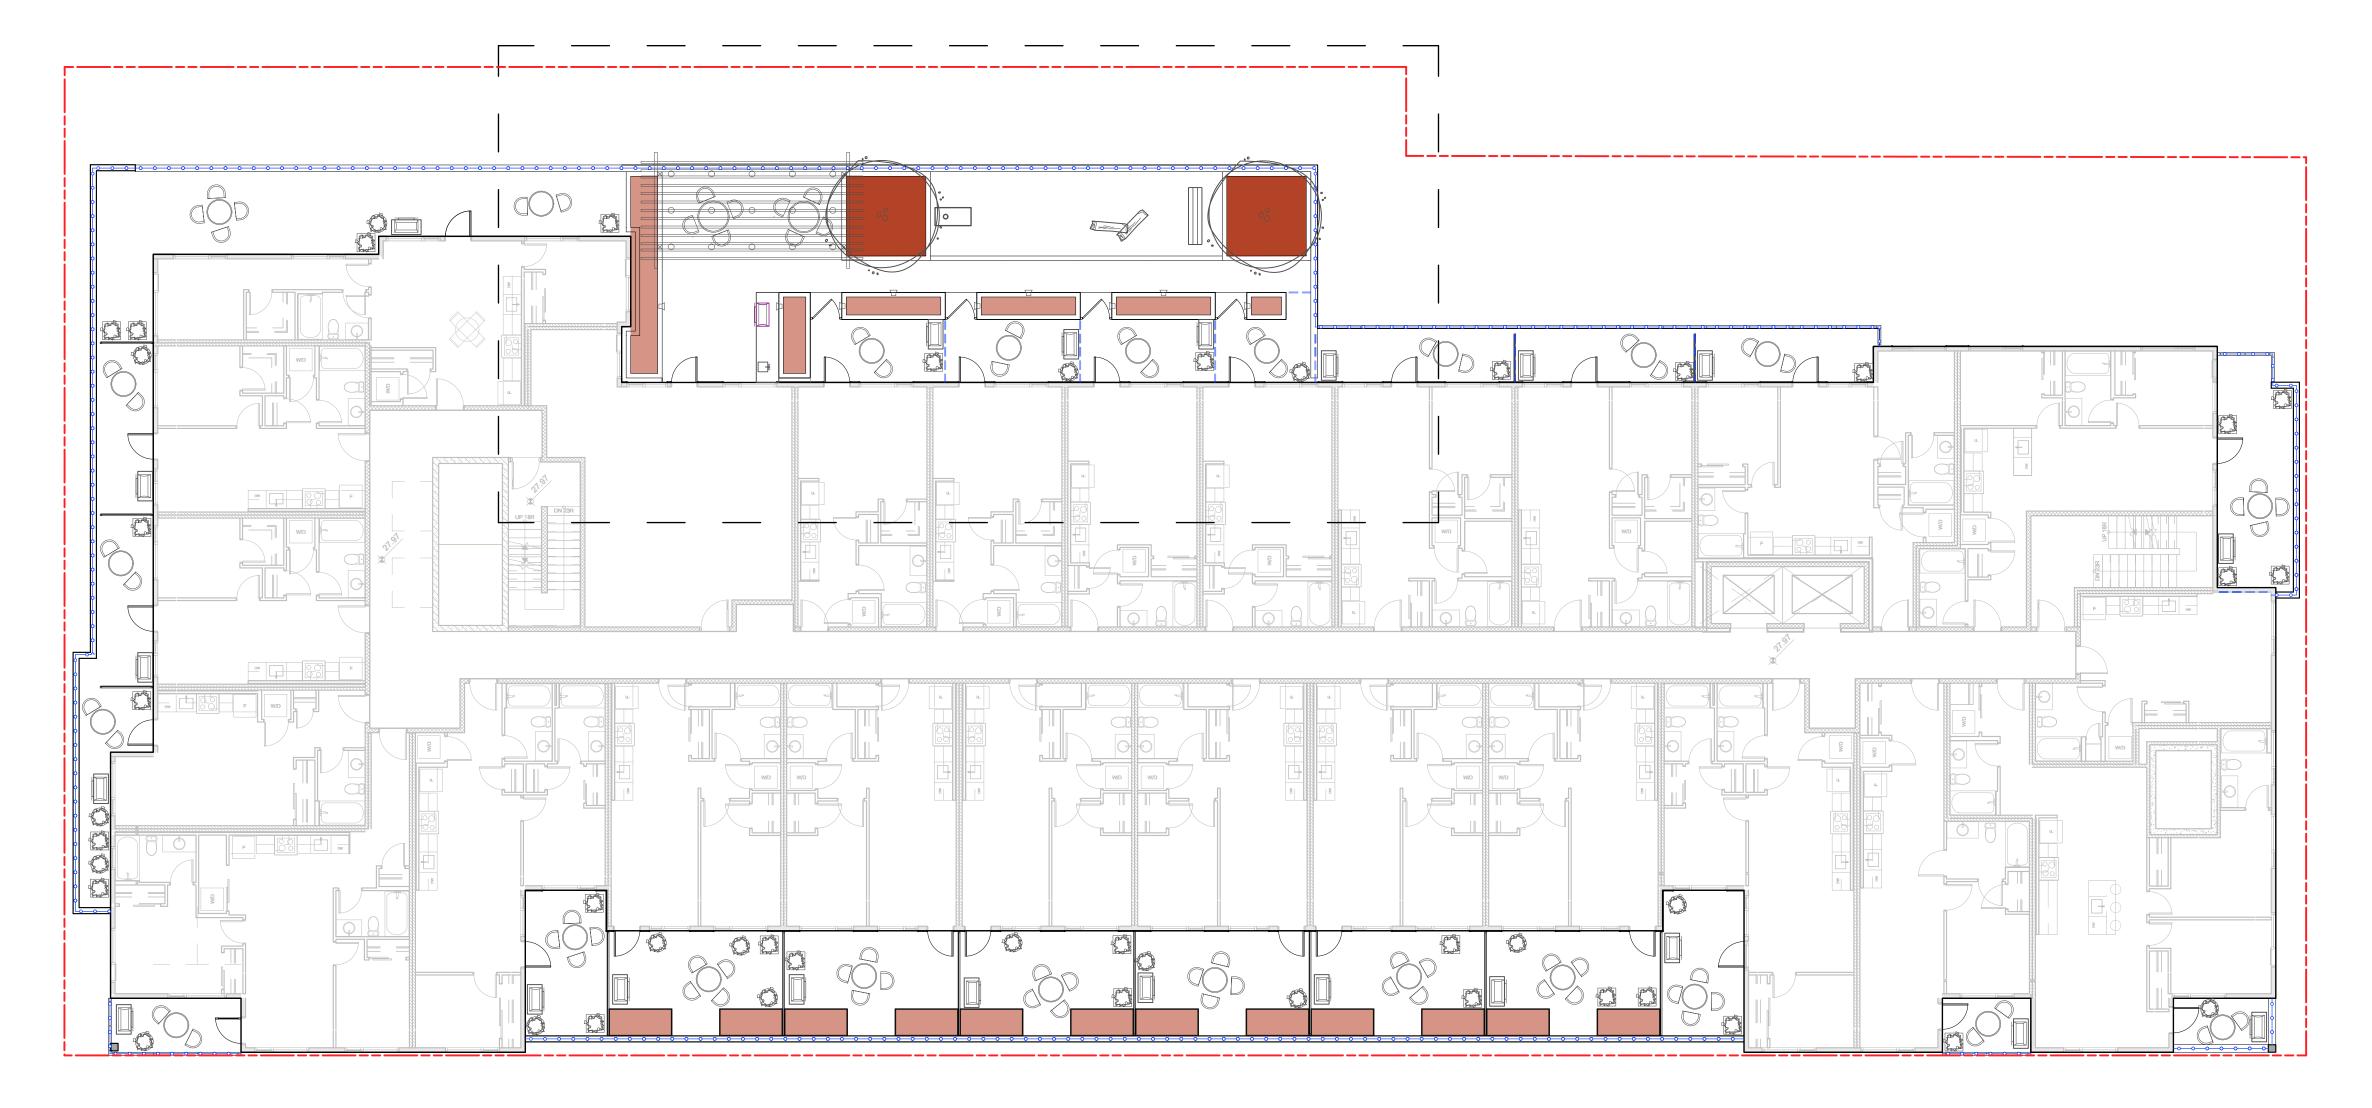

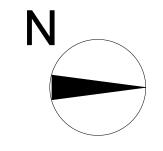

1 2023-03-03 For DP

2 2023-08-31 For DP Re-Submission



Project:

### E Columbia St New Westminister, BC

Draw by:	JC
Check by:	PK
Date:	Aug 31, 2023
Scale:	1/4" = 1'0"
	•


Drawing Title:


# Level 3 Soil Depths


Project No.: 22035

Sheet No.:

L-1.6

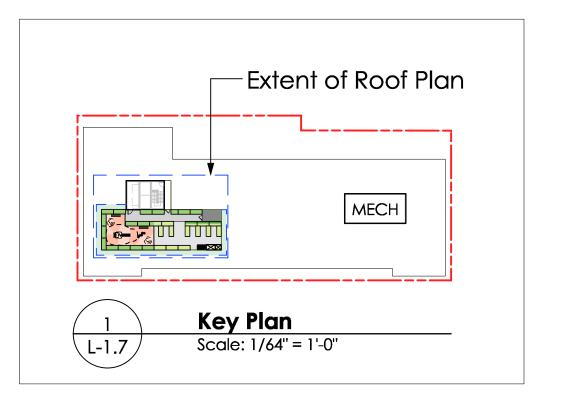

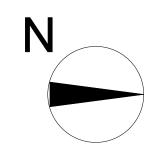

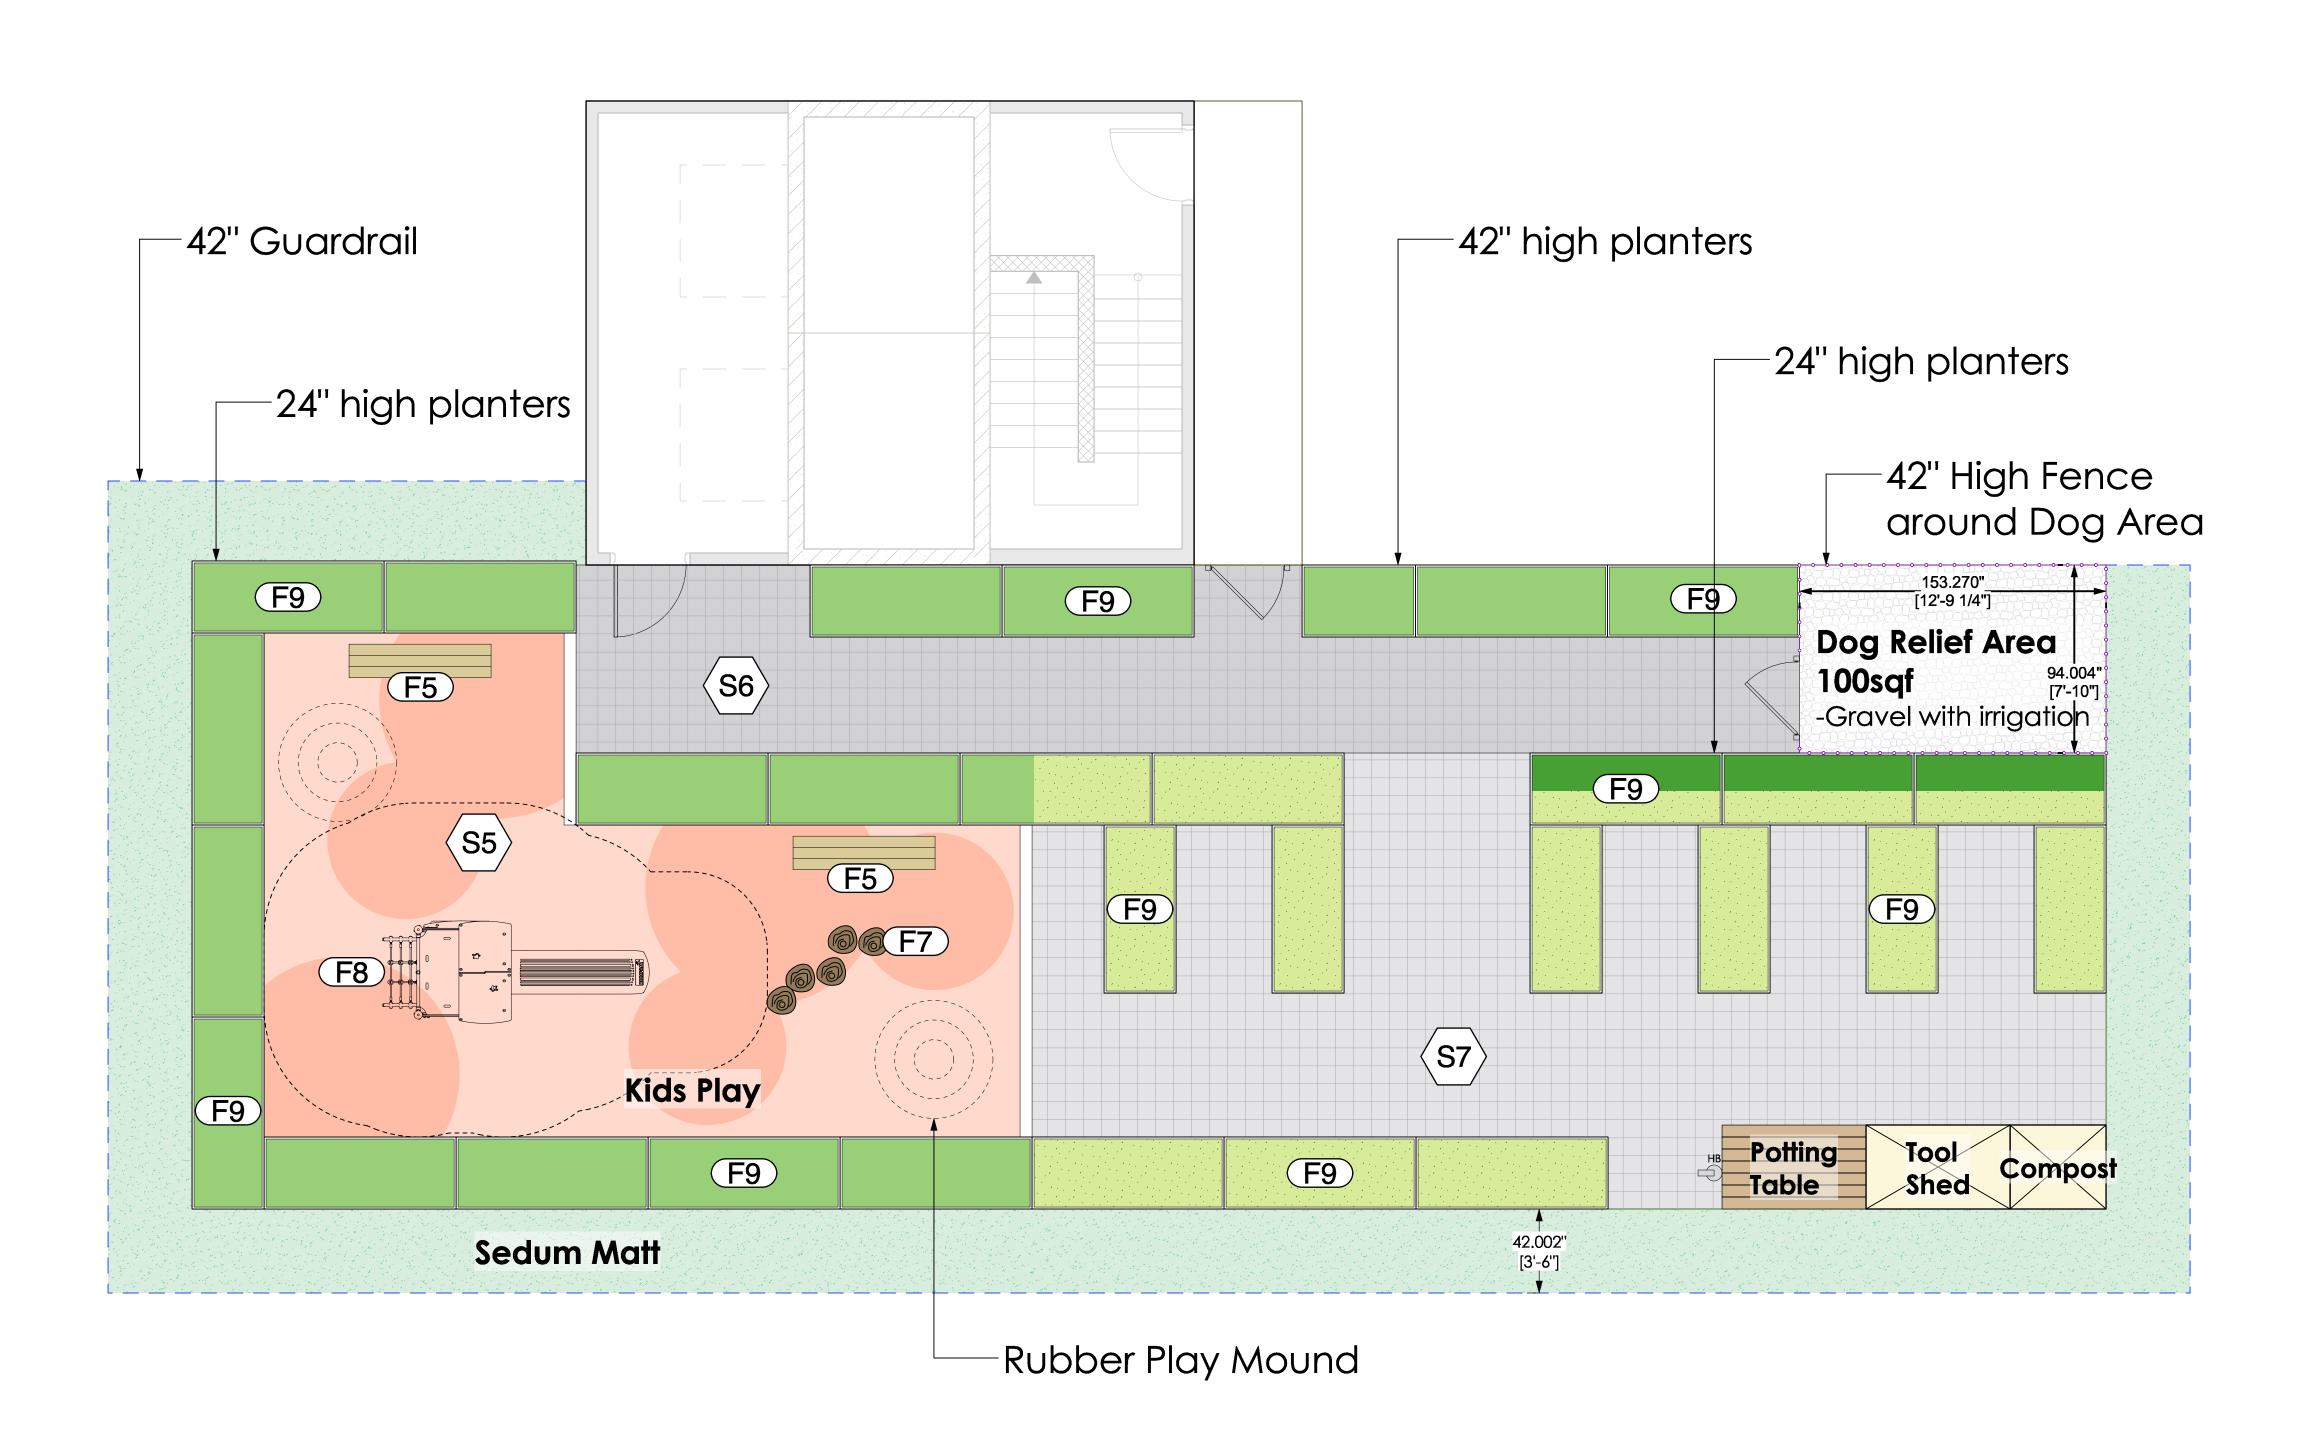

1 2023-08-31 For DP Re-Submission





E Columbia St New Westminister, BC


Draw by: JC Check by: Aug 31, 2023 1/4" = 1'0" Drawing Title:

**Roof Level Materials Plan** 

Project No.: 22035

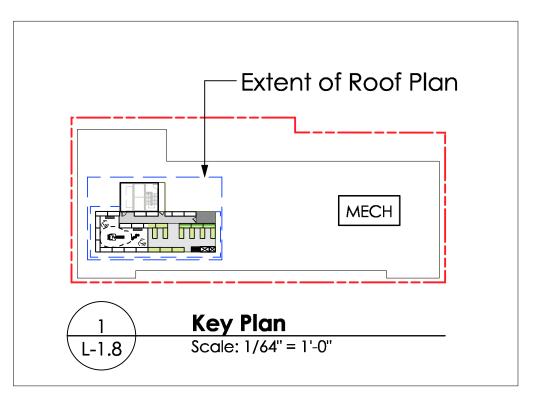

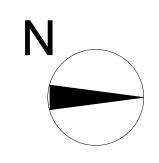

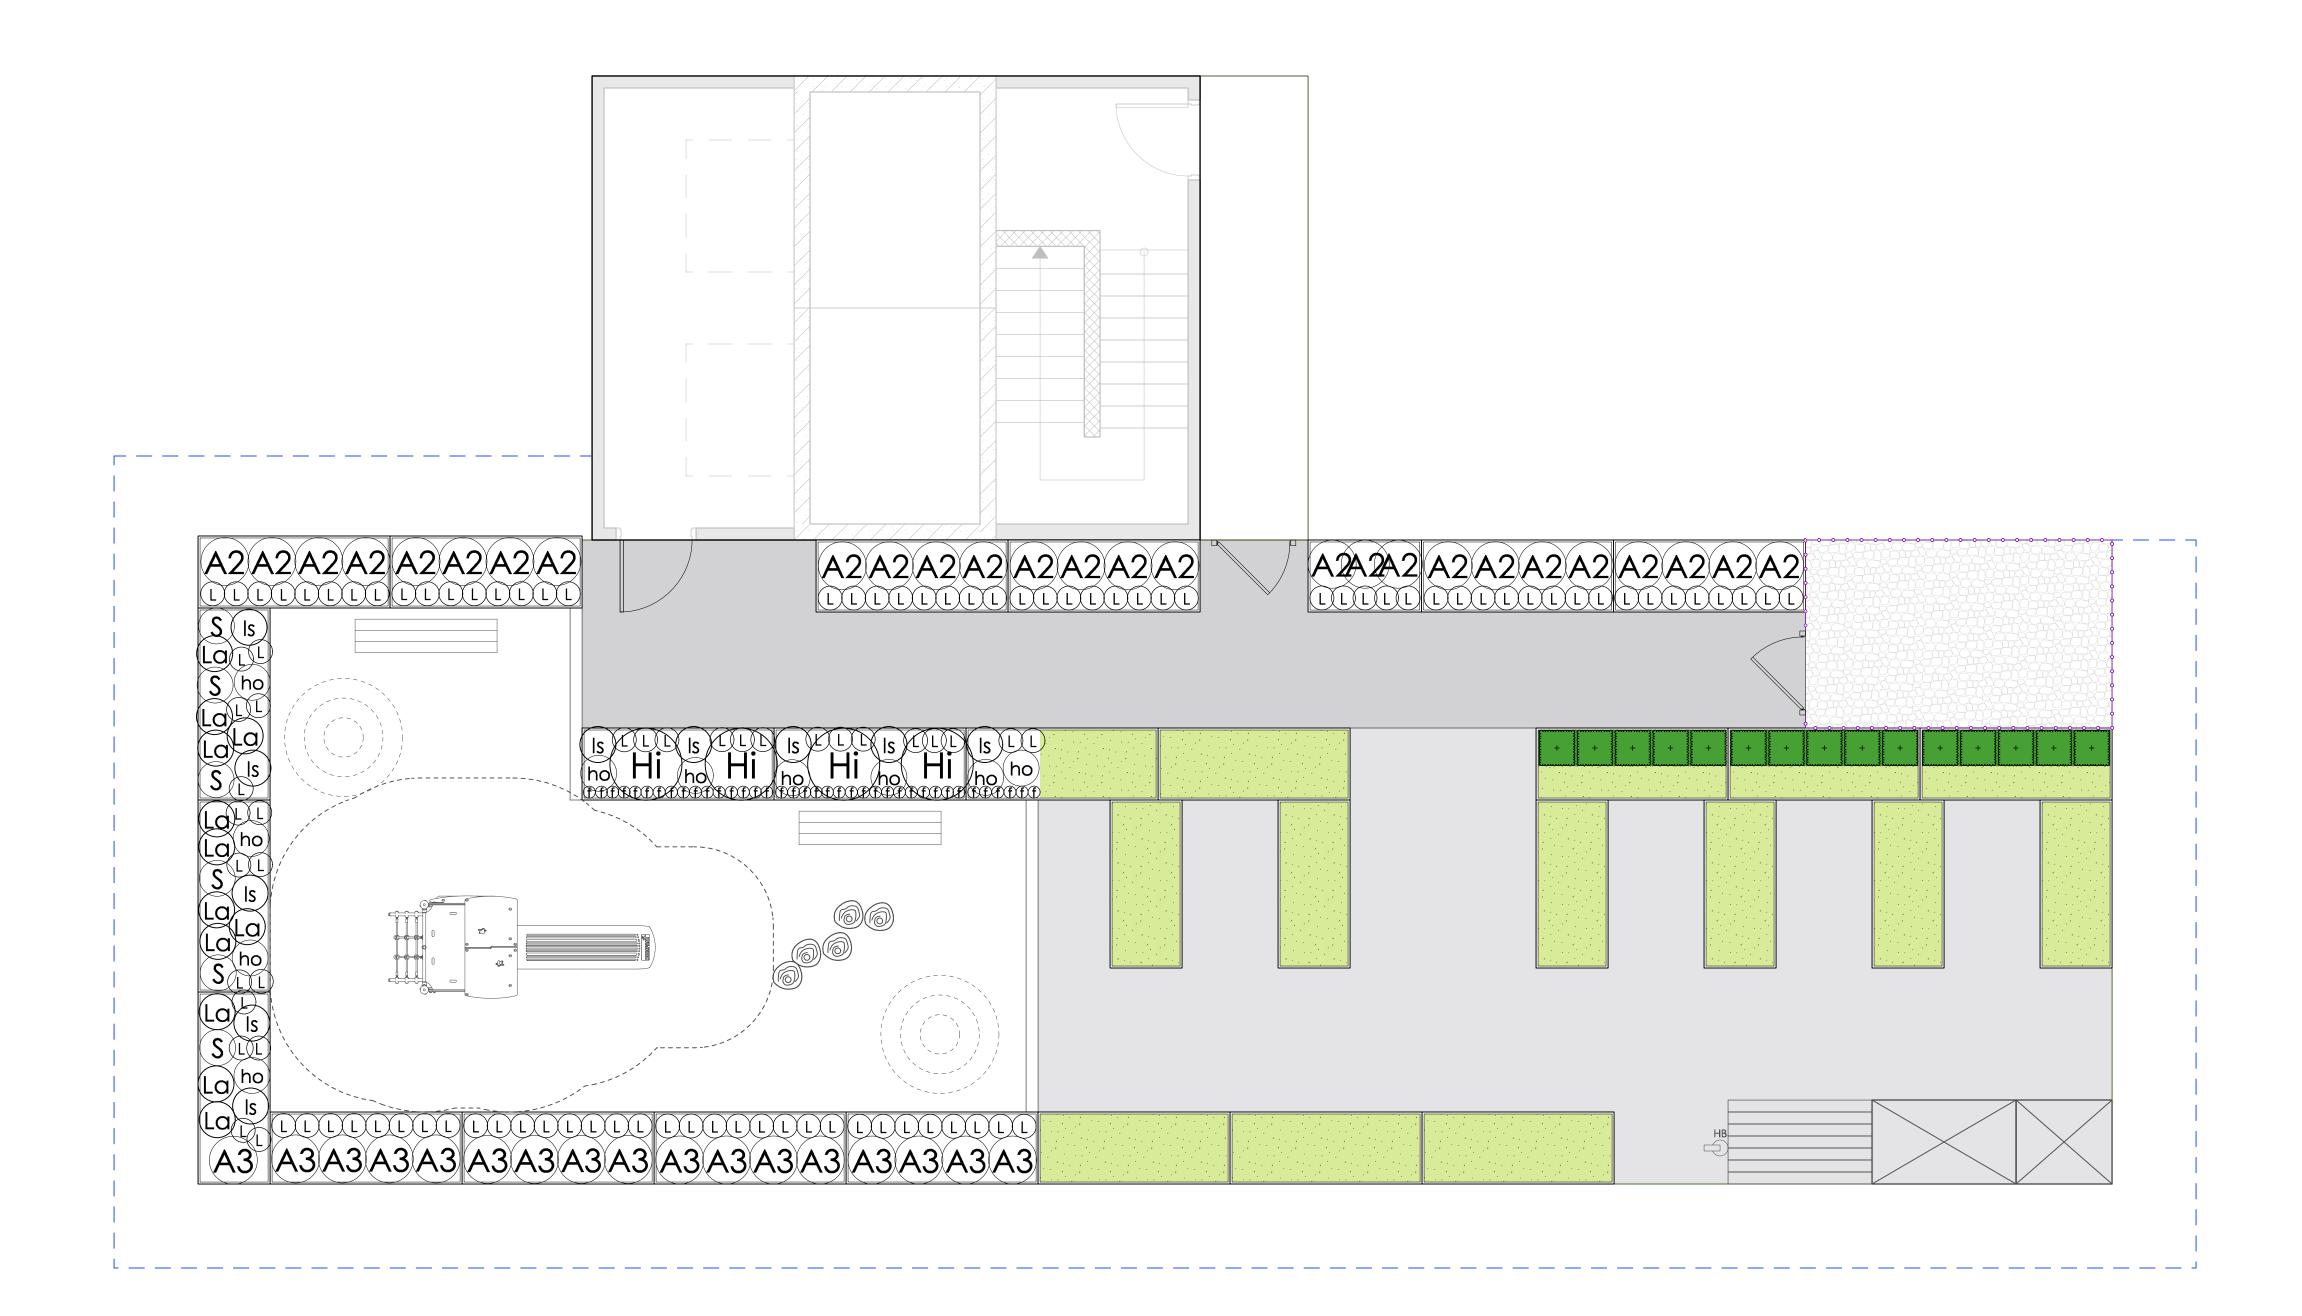

1 2023-08-31 For DP Re-Submission





### E Columbia St New Westminister, BC


Draw by: JC Check by: Aug 31, 2023 1/4" = 1'0" Drawing Title:


#### **Roof Level** Planting Plan

Project No.: 22035

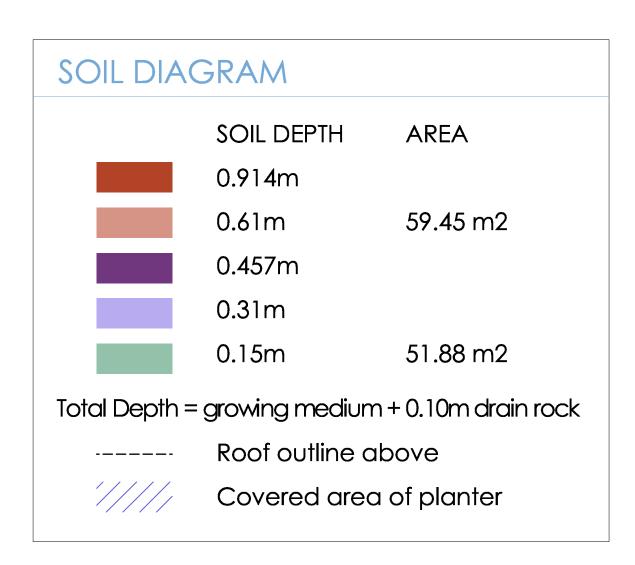

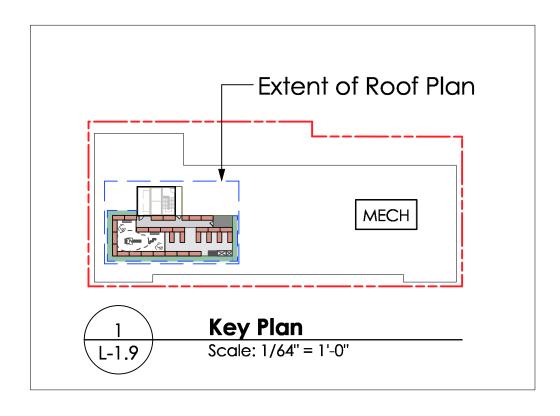

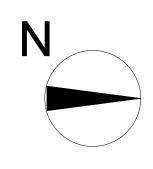

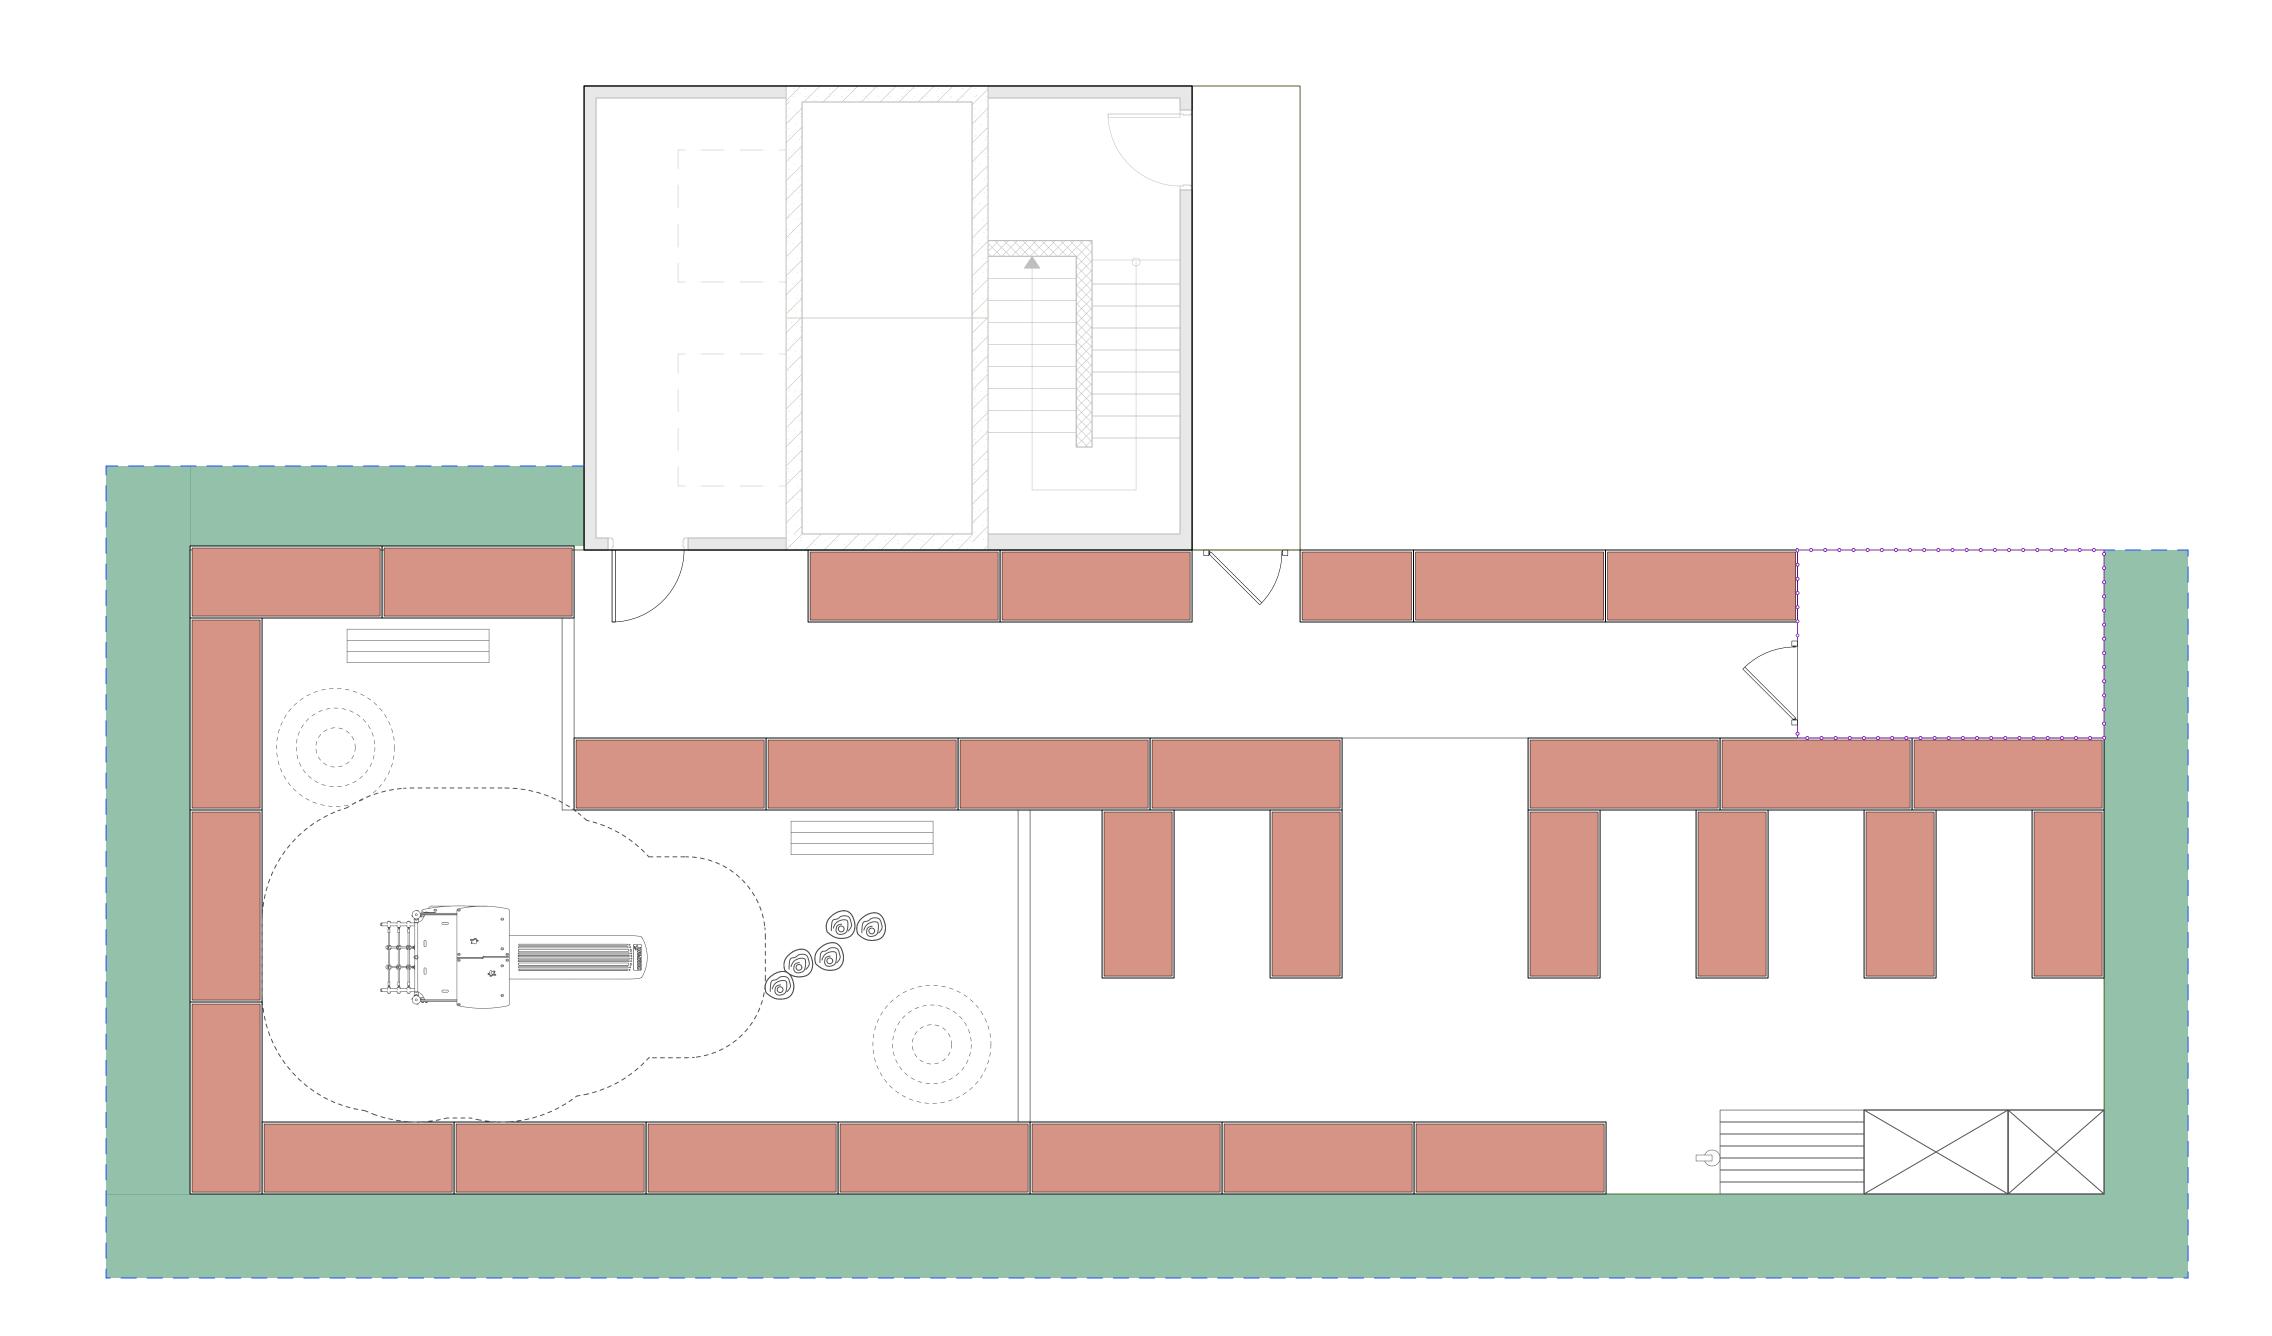

1 2023-08-31 For DP Re-Submission no.: date: item:

Revision:



Project:

### E Columbia St New Westminister, BC

Draw by: JC

Check by: PK


Date: Aug 31, 2023


Scale: 1/4" = 1'0"


Drawing Title:

#### Roof Level Soil Depths

Project No.: 22035

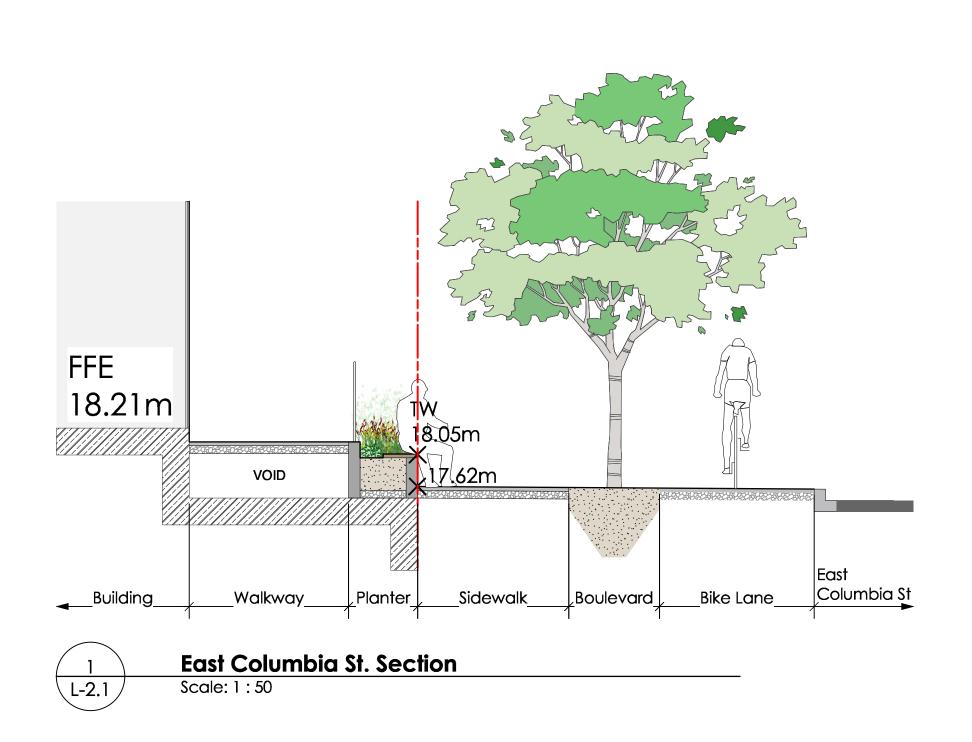

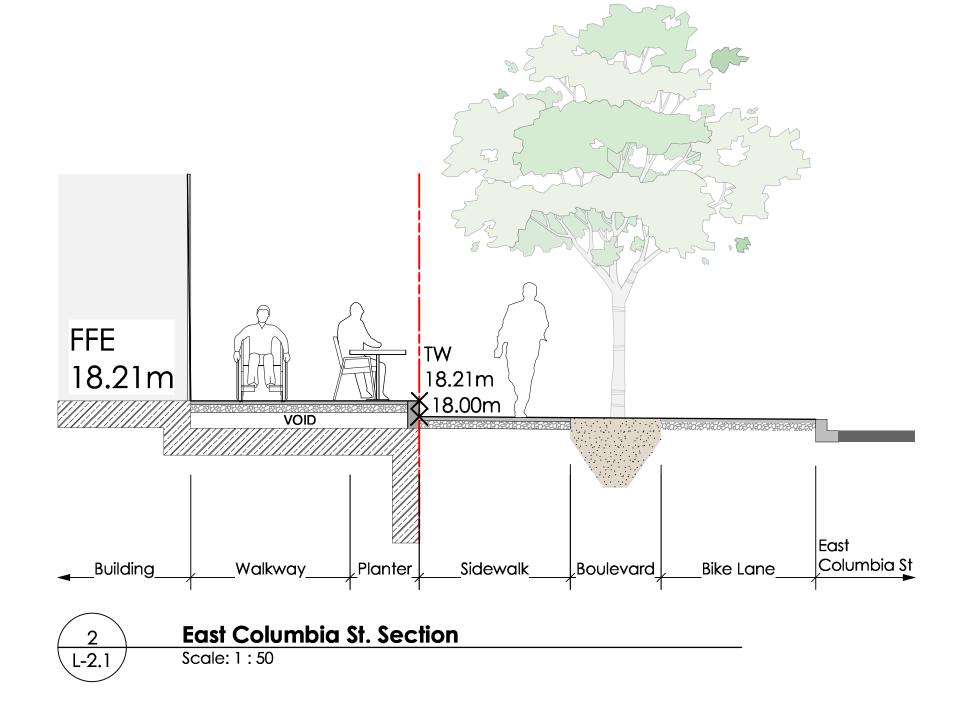

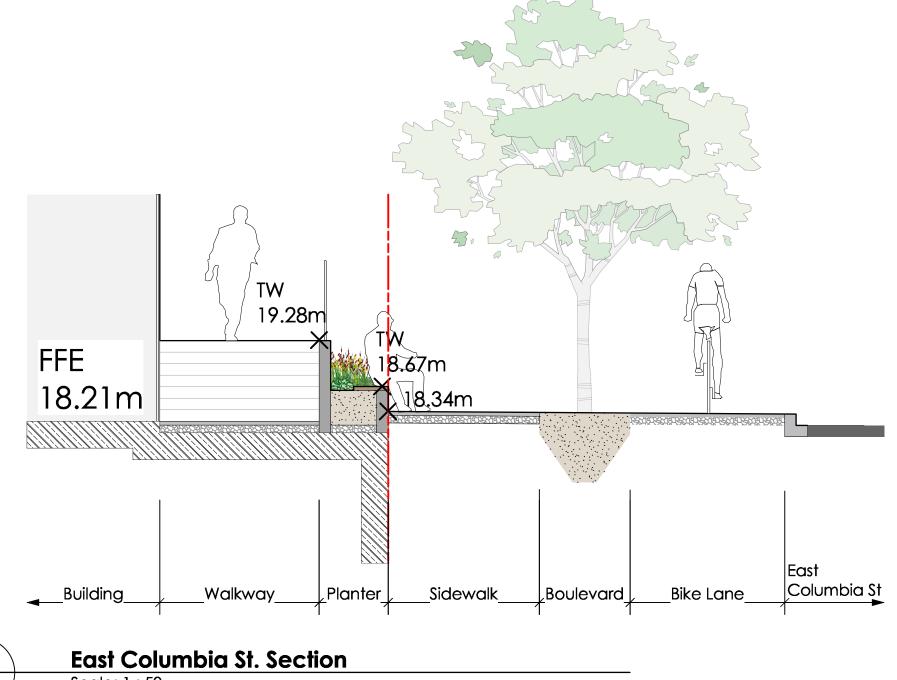

Scale: 1 : 50

Stepped planting and seating Bikes Stairs \_Stepped planting and seating\_ Stepped planting and seating Stairs \_Flush entry\_ Flush entry \_Planting\_ Flush entry

Project:

E Columbia St New Westminister, BC

2 2023-08-31 For DP Re-Submission

DURANTE KREUK LTD.
102 - 1637 West 5th Avenue
Vancouver B.C. V6J 1N5

P:604.684.4611 F:604.684.0577 www .dkl.bc.ca

2023-03-03 For DP

Draw by: JC Check by: Aug 31, 2023 As Shown Drawing Title:

#### Landscape Sections

Project No.: 22035 Sheet No.:

24.016" [2'-0"] ,36,000' [3'-0'] 42.000" [3'-6"] 36.000" [3'-0"] **■**Building Seating Area \_Planter\_ \_Multi-use play area\_ Planter


Level 3 Amenity Space  $\left(\begin{array}{c} 5 \\ \text{L-2.1} \end{array}\right)$ 

L-2.1


East Columbia St. Elevation

Scale: 1 : 100

L-2.1

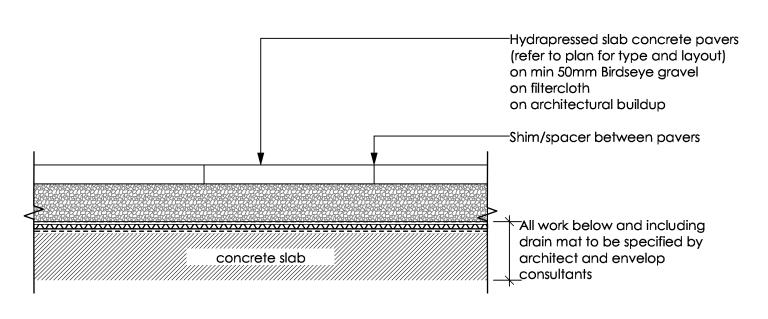




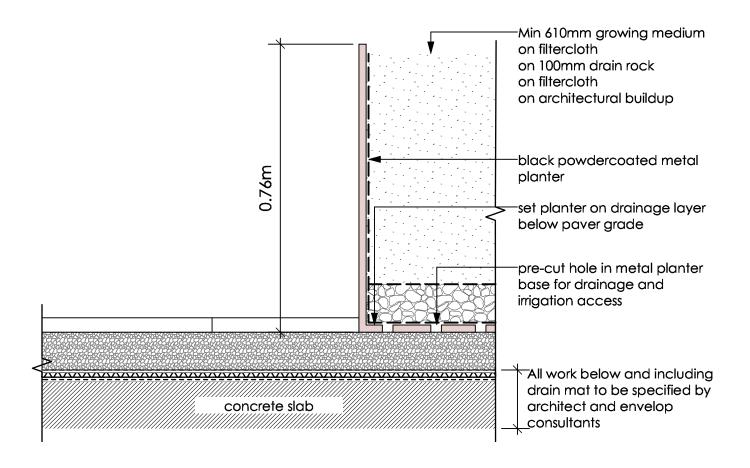



L-3.1


L-3.1

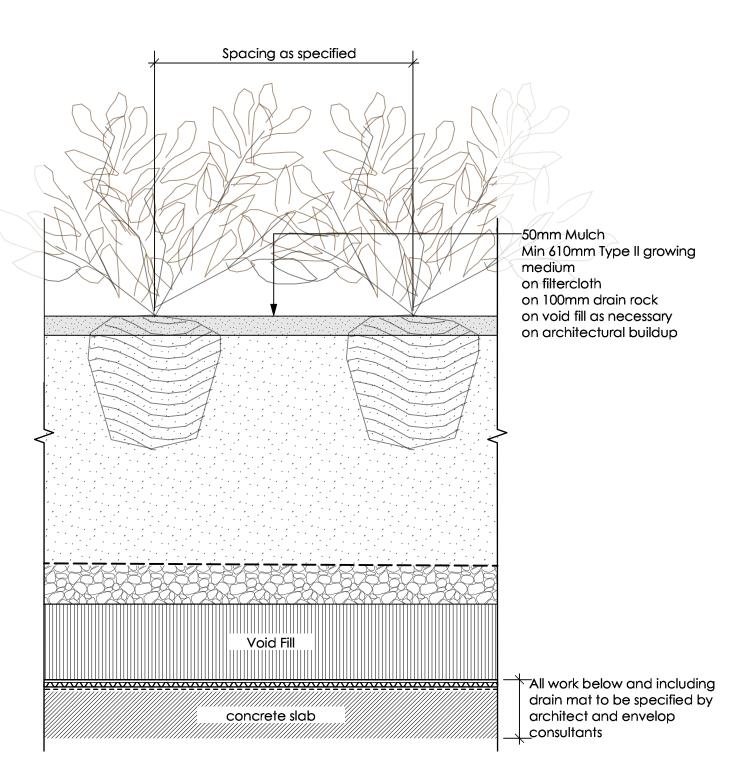


Shrub Planting and Concrete Planter Wall - On Slab (roof) Scale: 1 : 10

-Unit Concrete Pavers, (refer to plan for type and layout) on min 50mm Birdseye gravel on filtercloth on architectural buildup All work below and including drain mat to be specified by concrete slab architect and envelop \_\_consultants


Unit Concrete Pavers - On Slab Scale: 1 : 10

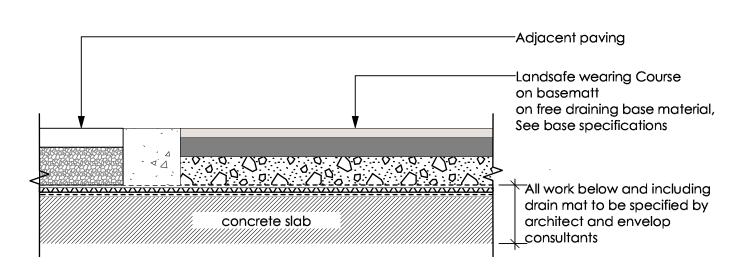


Poured in Place Rubber Play Surfacing - On Slab <u>5</u> L-3.1

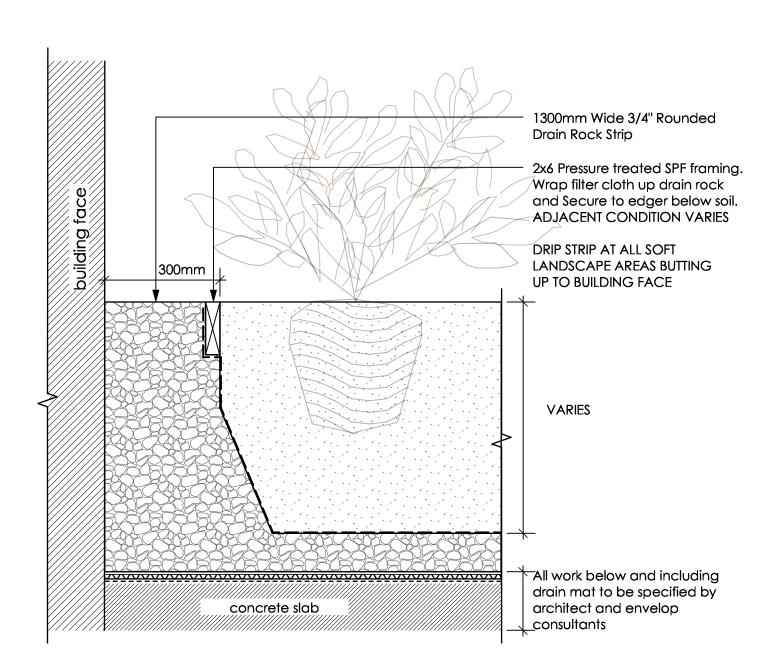

Drip Strip at Building Face - On Slab L-3.1 Scale: 1:10

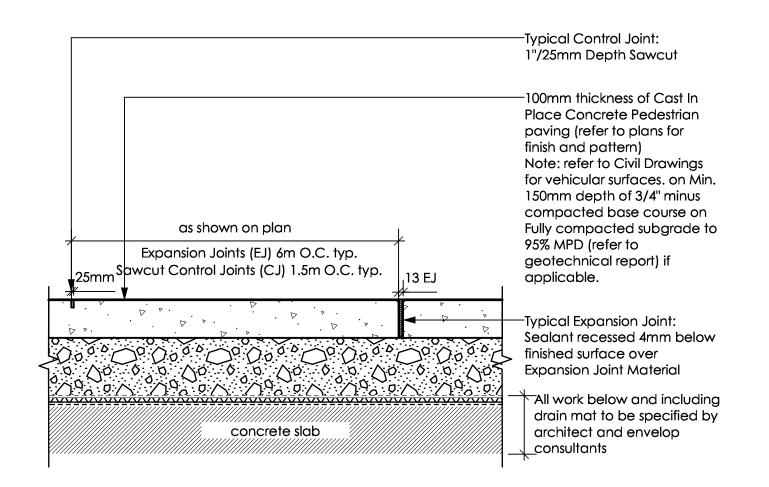


CIP Concrete - On Slab Scale: 1:10

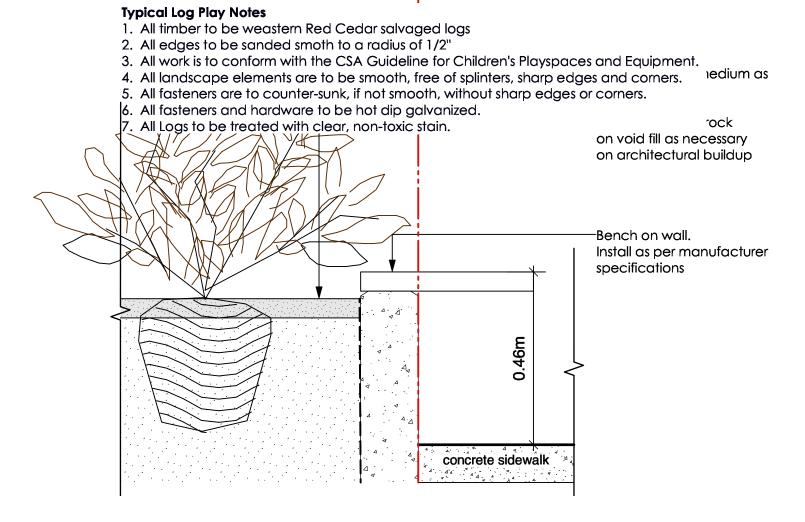

Concrete Planter Wall/ Seatwall + Shrub Planting - On Slab \L-3.1

#### Typical Metalwork Notes:

- 1. Submit Sealed / Engineered shop drawings for review and approval for all
- metalwork prior to fabrication and in accordance with specification section 05 50 00.
- 2. Confirm all dimensions on site. Modify as required to maintain design intent.
- 3. Consultant to approve all metalwork at fabrication prior to paint application.
- Assembly to be all-weld construction. Ensure all weld faces are ground smooth. 4. Steel metal work other than stainless steel to be powder coated charcoal to match architectural

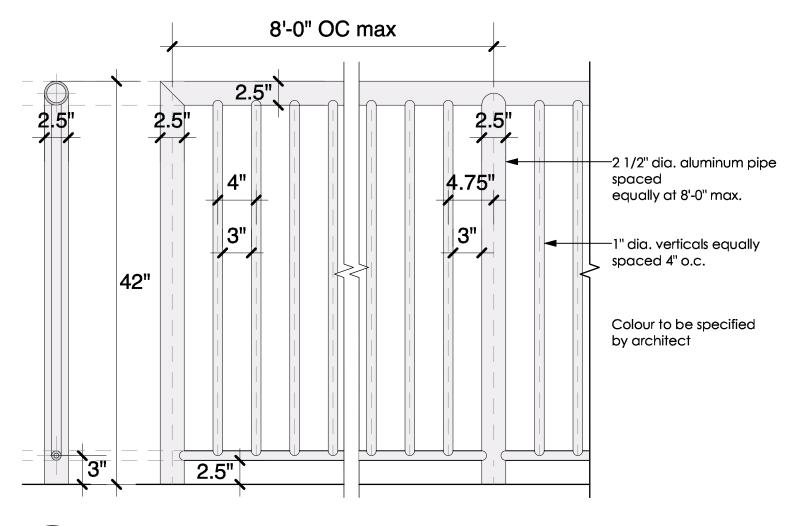

Metal Fence at Dog Area - Rooftop L-3.1 Scale: NTS

2023-03-03

2 2023-08-31 For DP Re-Submission For DP

Revision:



### E Columbia St New Westminister, BC

Draw by:	JC
Check by:	PK
Date:	Aug 31, 2023
Scale:	As Shown
Drawing Title:	

#### **Landscape Details**

Project No.: **22035** Sheet No.:

L-3.1

## NOTE: All fence material to be select western red cedar resawn. pressure treated (P.T.) Hem/fir where noted. All spikes and fasteners to be hot-dipped galvanized. —200mmØ Wood post at 2.4m o.c. max. max. -75x150 Trellis Rails notch post to recieve rails, through bolt with galv. carrage bolts. Provide 150mm clear between rails. -140x100 Bottom rail

Play Tower with Slide \* Max fall height | \*\* Total height | \*\*\* Safety surfacing area \* Max fall height | \*\* Total height PCM100121 \*100cm \*\*\*21.6m2

## **Generation 50**

Product Data Sheet

Kompan Play Tower with Slide

**Elevation** 

Scale: 1 : 20

L-3.2

L-3.2

**6ft Wooden Perimeter Fencing** 


landscapeforms


The Generation 50 line of benches and litter receptacles is a modern interpretation of several of the company's classic designs. "Generation 50 pays homage to the design, culture, and craft that is at the heart of the company but also takes advantage of the manufacturing expertise and new technologies that characterize Landscape Forms now and into the future," says Generation 50 designer Robert Chipman. Angular, diamond-shaped detailing is the shared visual character across the line's pieces. Generation 50's many options and broad application fit multiple site designs and uses. Benches can be specified with or without backs; in traditional, cantilevered, top-of-wall mounted, and wall mounted styles; with curved or straight face boards; and with three arm options or without arms. A litter receptacle in two styles rounds out the line. The elements are made of cast aluminum, steel, and wood, including thermally modified ash, a domestically sourced, sustainable material.

Style	Depth	Width / Length	Height	Weight
Traditional Backed with (2) Arms	26"	72"	33"	139 lbs




Section

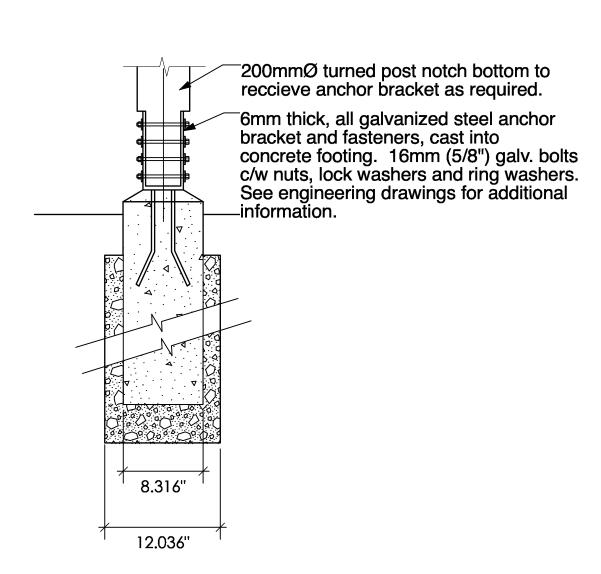

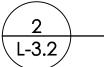


#### **Fence Post Footing**

Scale: 1:10

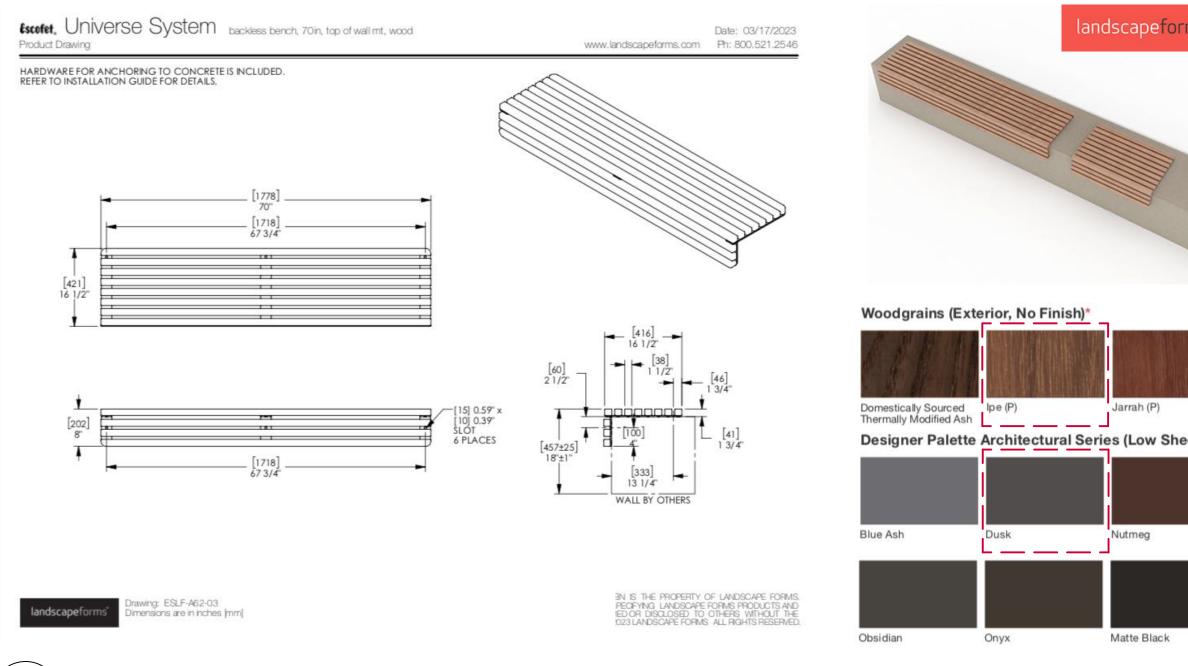



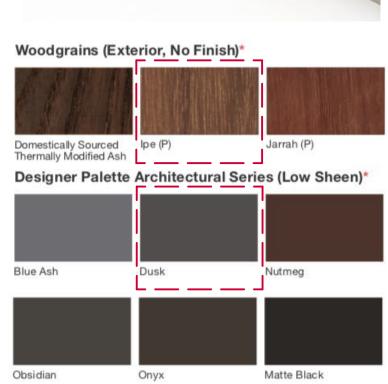

#### Top of Wall Bench Scale: NTS

landscapeforms

### **NeoLiviano Bench**

**Product Data Sheet** 

The NeoLiviano bench is a lyrical variation on NeoRomantico. Lighter in structure and form it has arms for extra comfort. Its slim profile coupled with a strong cast aluminum structure and wood slat seat and back make it versatile seating for both public and private spaces.

Backed	Style	Depth	Width	Height	Product Weight
Rooftop	69"	26.5"	69'	31"	96 lb
Level 3	59"	19.5"	59"	17"	51 lb



#### Bench

- Benches are available backed or backless.
- Bench can be freestanding, surface mounted, or embedded.
- Supports come in an anodized finish with no color options.
- Center arm option available for 118" bench only. Available only in Jarrah and Domestically Sourced Thermally Modified Ash (DSTMA)

#### Finishes

- Anodized Aluminum Finish for Supports.
- Unfinished Exterior Woods.
- Interior Woods with LF-80 Finish.

Draw by: JC Check by: Aug 31, 2023 As Shown

E Columbia St New Westminister, BC

#### **Landscape Details**

Drawing Title:

2 2023-08-31

Revision:

Project:

2023-03-03

For DP Re-Submission

DURANTE KREUK LTD.

P:604.684.4611 F:604.684.0577 www .dkl.bc.ca

102 - 1637 West 5th Avenue Vancouver B.C. V6J 1N5

For DP

Project No.: **22035** Sheet No.:

L-3.2

Benchs at L3 and Rooftop

Kompan Play Tower with Slide

#### [V] MPLIGHTING

### L46


#### EXTERIOR | INTERIOR

Steplight | For walls, stairs, and walkways.

Wet, Damp, and Dry location



Side View

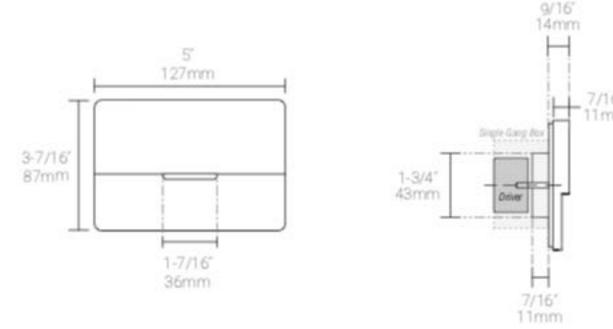





## **Tumbler**

Housing: Die-cast aluminum

Lens: Tempered glass (clear or opal / diffused)

Light Source: PCB LED - Cree XPG2, CoB LED - Birdgleux Gen 7

Color Temperature: 3000K, 4000K

Power Supply: 120V-277V

Dimming: 1-10V (DALI available upon request) Protection Class: IP66

Weight: 14.5 lbs (luminaire only)

**EPA:** 0.84 ft<sup>2</sup>





Down Light in Canopy - L3

Scale: NTS



#### Series 12

#### **Express Lollipop Bike Rack**

#### GENERAL SPECIFICATIONS

produce a mar resistant finish.

Metal: All Series 12 Express Lollipop bike rack frames are constructed of 1.9" (4.8cm) outside diameter steel pipe. The metal is powder coated with electrostatically applied polyester and baked at a high temperature to

Hardware: A special wrench for vandal resistant hardware is supplied with each bike rack. All hardware is professionally finished with our baked-on polyester powder coating.

#### INSTALLATION OPTIONS

The Series 12 Express Lollipop bike rack is available in bolt-down or in-ground configurations.

In-ground: E12-BR01 installs directly into concrete to a depth of 12".

Bolt-down: E12-BR02 is fastened directly to the ground using 3/8" bolts (not provided). Vandal-resistant flush nuts are included for additional security.

#### METAL COLOURS


L-3.3


Choose from our 26 standard paint colours, or for an additional charge, choose from over 160 custom paint colours. Standard colour chips and custom colour charts are available upon request.

**Bike Rack** 

Scale: NTS

#### E12-BR01

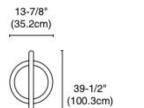

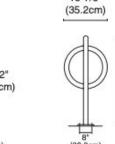

E12-BR02

13-7/8"

39-1/2" (100.3cm)



2 2023-08-31 For DP Re-Submission 2023-03-03

For DP

Revision:



# E Columbia St New Westminister, BC

Draw by:	JC
Check by:	PK
Date:	Aug 31, 2023
Scale:	As Shown

#### **Landscape Details**

Project No.: **22035** 

Drawing Title:

Sheet No.:

L-3.3